

MATERIALS CODE DESCRIPTION MANUFACTURER MODEL					
CODE	DESCRIPTION	WANDFACTURER	WODEL		
AUD	All AID CAD				
AIR ALU	1" AIR GAP CLEAR ANODIZED ALUMINUM, MULLION TYP				
BK	THIN BRICK FINISH	PINE HALL BRICK,	BROWNS FERRY		
CF-1	CONCRETE FOUNDATION, SEE STRUCTURAL		SEE STRUCTURAL		
CMU2	SPLIT RUNNING CMU, 4" THICK NOMINAL, COLOR GREY	YORK BUILDING PRODUCTS	SPLIT FACE CMU COLOR 518 FLINT		
CMU8	CMU, 8" NOMINAL				
FL-1	CONCRETE PAD, BROOM FINISH - SEE STRUCTURAL				
FL-2	CONCRETE SIDEWALK, AS PER INDUSTRY STANDARDS AND GOVERNMENTAL REQUIREMENTS, SEE CIVIL DRAWINGS				
GR-2	THIN MORTAR				
GRD GYP2	MTL SCREEN 5/8" GYP. BD SEE WALL DET &				
IG-1	NOTE 1 1 IN CLEAR, TEMPERED INSULATED LOW-E W/ BLUE REFLECTION, WITH WRITTEN VERIFICATION FROM GLASS COMPANY, DUAL SEALED UNITS, SEE SCHED.	KAWNEER	LOW-E INSULATED TEMPERED GLAZING W BLUE REFLECTION		
IG-2	1 IN CLEAR, TEMPERED INSULATED LOW-E, WITH WRITTEN VERIFICATION FROM GLASS COMPANY, DUAL SEALED UNITS, SEE SCHED.	KAWNEER	LOW-E INSULATED TEMPERED GLAZING		
IG-3	1" INSULATED SPANDREL GLAZING, UP TO 10 A.F.F. SEE SCHED.	KAWNEER	INSULATED SPANDREL GLAZING		
MS-1	GALVANIZED WIRE MESH- LADDER GATE		GLAZING		
P-M1	BLACK PAINTING, MATTE FINISH, OVER GALVANIZED MTL SURFACE	SHERWIN WILLIAMS	BLACK		
P-M3	SIGNAGE MTL PAINT - BLACK, SATIN FINISH	WILLI/ WIO			
PT-1	EIFS, COMPLETE FINISH, COLOR SW9098 BAKED COOKIE	DRYVIT	COLOR SW9098 BAKED COOKIE		
PT-2	EIFS, COMPLETE FINISH, COLOR SW9170 ACIER.	DRYVIT	COLOR SW9170 ACIER		
PT-3	GREY PAINTING, MATTE FINISH, OVER GALVANIZED MTL SURFACE	SHERWIN WILLIAMS	GREY		
PT-4	DARK GREY PAINTING, MATTE FINISH, OVER GALVANIZED MTL SURFACE	SHERWIN WILLIAMS	DARK GREY		
PT-5	GREY PAINTING, SATIN FINISH, OVER GALVANIZED MTL SURFACE	FIRESTONE	Duracast Dove Gray		
PT-6	1/2" 18GA MTL PANEL W/ EXPOSED FASTENERS, INSTALL CORRUGATIONS ON HORIZONTAL. PROVIDE ANGLES BEHIND PANELS TO 2X4IN TUBE STEEL GATE STRUCTURE. BLACK PAINT FINISH.	SHERWIN WILLIAMS	BLACK		
PT-7	PAINTING COAT ON EXTERIOR MTL SURFACE, COLOR BLACK, AS DTE STANDARDS.	SHERWIN WILLIAMS			
RF-2 RF-3	R-30 MIN. CONT RIGID INSULATION WHITE 60 MILL FIRESTONE	FIRESTONE	ULTRAPLY PTO		
	ULTRAPLY TPO MEMBRANE, MECHANICALLY FASTENED OVER 5" (2X2.6") RIGID INSULATION, MIN R-VALUE OF 20	TINLOTONE	MEMBRANE		
SH-1	5/8" EXTERIOR GRADE PLYWOOD SHEATHING				
SH-2	1/2" EXTERIOR GRADE PLYWOOD SHEATHING				
SH-R	USG SHEETROCK 5/8" PANEL (UL AR)	USG	USG Sheetrock Brand 5/8" panel (UL AR)		
ST2	PRE CAST SILL, COLOR LIMESTONE	STONECAST	LIMESTONE		
STD-3	3 1/2" DEEP 20 ga. STEEL STUDS W/ 3" MINERAL WOOL BATT INSULATION				
STD-6	6in DEEP, 25ga, SPACED MAX 24IN O.C., W/ FIBERGLASS INSULATION				
VN-1	BLACK VINYL				
VN-2	RED VINYL				
VN-3 VN-4	WHITE VINYL YELLOW VINYL		3630-125 GOLDEN YELLOW		
WD-1	WOOD SLATS		I LLLOVV		
WD-2	PRESSURE TREATED PINE OR				
	EQUIVALENT				

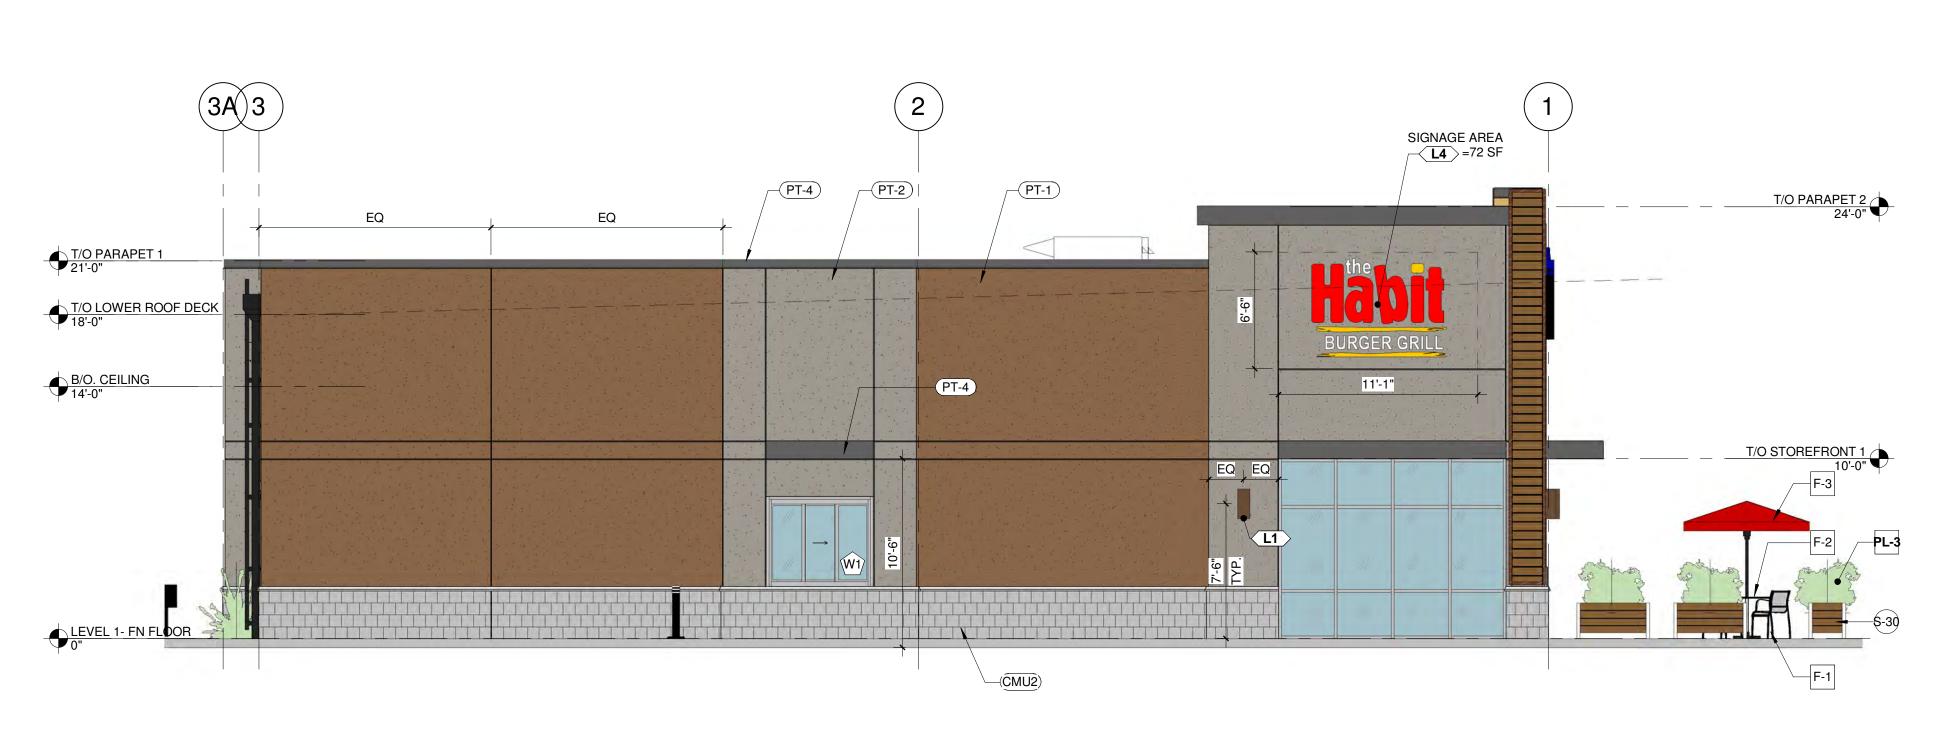

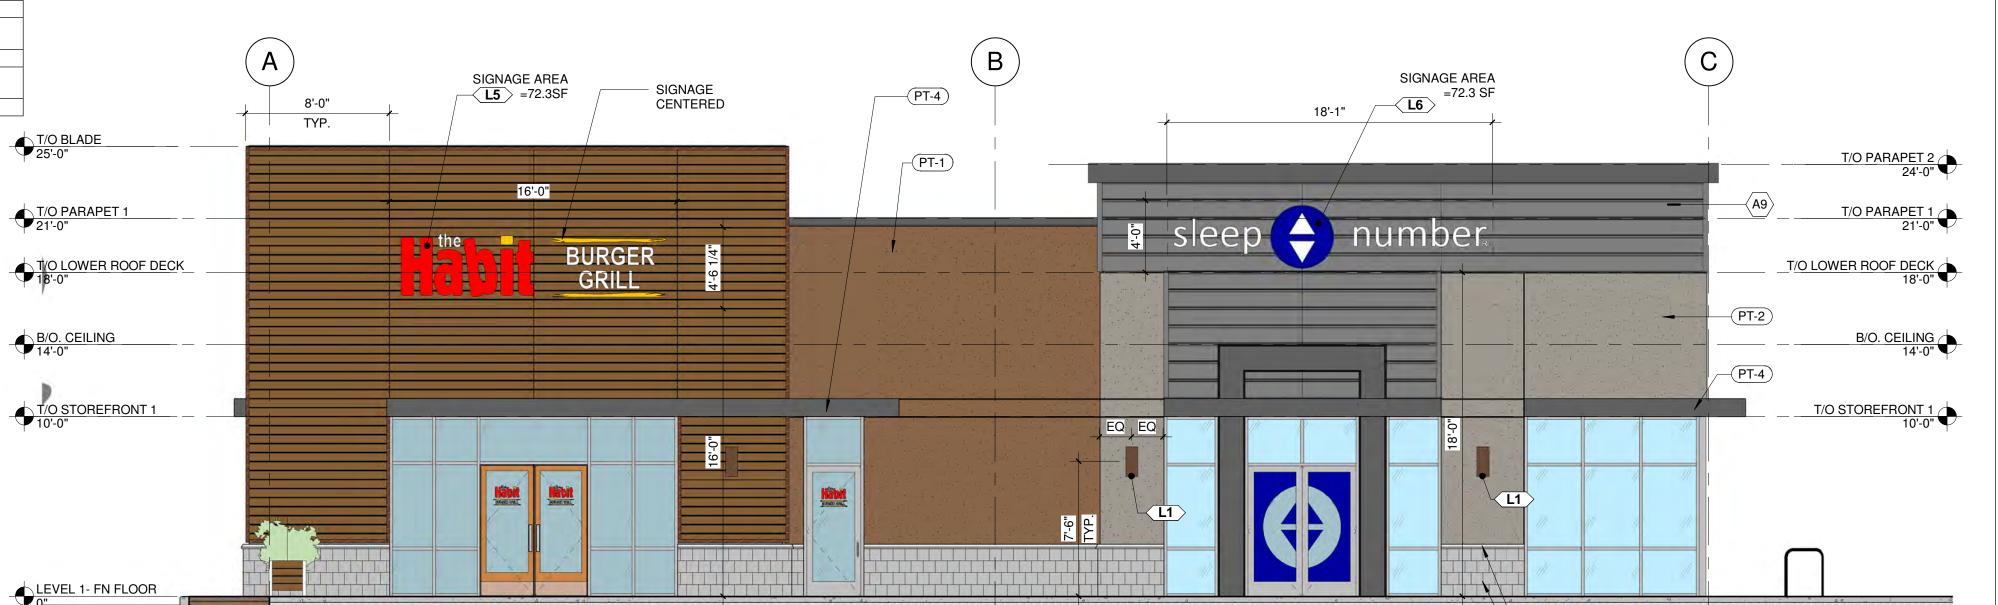

EXTERIOR ELEVATION NOTES

GENERAL CONTRACTOR TO COORDINATE & SCHEDULE SIGNAGE INSTALLATION WITH THE SIGNAGE CONTRACTOR PROVIDING A MINIMUM SCHEDULING NOTICE OF 4 WEEKS AND 1 WEEK PRIOR TO SCHEDULED DATE OF INSTALATION. CONSTRUCTION MANAGER TO PROVIDE GENERAL CONTRACTOR WITH SIGNAGE CONTRACTOR CONTACT INFORMATION.

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GENERAL KEYNOTES

- B-1 NON-ILLUMINATED BOLLARD
- C10 6" DIAMETER STEEL CONCRETE FILLED PIPE
- BOLLARD, SEE STRUCTURAL C15 DERO HOOP BIKE "U" RACK, 14.5"x34"x1 5/8", 12
- **GA STEEL** F-1 PASO DOUBLE CHAIR, ARMS PKG OF 2
- F-2 SQUARED TABLE, 2'X2', BLACK FINISH F-3 OUTDOOR UMBRELLA
- FT CONCRETE FOOTING SEE STRUCTURAL IG-1 1" INSULATED LOW-E CLEAR GLAZING PANELS,
- DUAL SEALED UNITS. IG-3 1" INSULATED SPANDREL GLAZING L1 OUTDOOR WALL SCONCE, FLUSH MOUNT, SEE
- ELECTRICAL L2 OUTDOOR WALL SCONCE OVER SERVICE DOOR,
- SEE ELECTRICAL L4 HABIT ILLUMINATED SIGN - STACKED LOGO
- L5 HABIT MESA STANDARD ILLUMINATED LOGO
- L6 SLEEP NUMBER STANDARD LOGO L-A SITE POLE LIGHTING TYPE A - SEE ELECTRICAL
- SHEETS FOR SPECS L-EX EXISTING SITE POLE, NEW LOCATION - SEE **ELECTRICAL**
- M1 RTU#1, TYPICAL RTU LOCATION SHOWN REFER TO TENANT CONSTRUCTION DOCUMENTS FOR EXACT LOCATION OF ALL ROOF EQUIPMENT AND
- M-7 AIR CURTAIN AT DRIVE-THRU WINDOW, SEE RCP NOTE #4 AND M2-01 FOR SPECS
- P-1 SINGLE PARKING, DIM 9'x18', REFLECTIVE WHITE
- P-2 SINGLE PARKING, DIM 9'x16', REFLECTIVE WHITE
- P-3 ADA PARKING, DIM 8'x18', REFLECTIVE WHITE
- PL-1 CREEPIN JUNNIPER
- PL-2 HYDRANGEA
- PL-3 STAR JASMINE

NORTH ELEVATION
SCALE: 3/16" = 1'-0"

2 WEST ELEVATION
SCALE: 3/16" = 1'-0"

(CMU2)

- S-1 STOP SIGN AND PAINTED BAR, WHITE LEGEND RED BACKGROUND
- S-2 TURN ARROW, REFLECTIVE WHITE PAINT
- S-4 RESERVED PARKING SIGN, GREEN LEGEND, WHITE BACKGROUND
- S-5 FLOOR PAINT STOP SIGN, REFLECTIVE WHITE
- S-7 FLOOR PAINT STOP ARROW, REFLECTIVE WHITE
- S-9 FLOOR PAINT ADA PARKING AREA STRIPING. S-19 ADA SIGN, W/ WHITE BACKGROUND, REFLECTIVE
- WHITE PAINT
- S-21 CAUTION STRIPED PAINTING S-22 MONUMENT SIGN - INTERNALLY ILLUMINATED.
- S-30 PLANTER
- S-31 TRASH DUMPSTER
- S-32 NEW CURB S-35 PARKING CONCRETE PROTECTION CURB
- SE2 ROOF ACCESS SERVICE LADDER WITH GATE
- SE-1 PRE-MENU BOARD SE-2 MENU ORDER BOARD PLACEMENT PANEL AND
- SE-3 8'-6" CLEARANCE BAR
- SE-4 THRU WALL SCUPPER WITH COLLECTOR HEAD AND DOWNSPOUT
- SE-5 1'x1' ROOF WALKWAY PADS
- ST2 STONE SWEEP, SEE WALL DETAILS
- ST-1 BEARING STRUCTURE, SEE STRUCTURAL
- W1 COMMERCIAL, DOUBLE SLIDE THERMAL ALUMINUM WINDOW



Municipal Approval Stamps



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THOMAS ENGLISH

725 E. 65TH STREET, STE 300 INDIANAPOLIS, IN 46220

Client

PROPOSED RETAIL DEVELOPMENT 1961 S. VAL VISTA DR

MESA, AZ 85204

Project

Consultant

02/05/2018 ZONING/ DESIGN REVIEW

PROFESSIONAL CERTIFICATION: I CERTIFY THAT THESE DOCUMENTS WERE PREPARED OR APPROVED BY ME, AND THAT I AM A DULY LICENSED ARCHITECT UNDER THE LAWS OF THE STATE OF ARIZONA, LICENSE NUMBER 59402.

11/20/2017 INITIAL ISSUE

NO. DATE REVISIONS/ISSUANCES



FOR PERMIT/ FOR BID 02/05/2018 DATE: DXU#17-264 PROJECT NUMBER: 3/16" = 1'-0" SCALE:

DTE

BG

ES


EXTERIOR ELEVATIONS

DRAWN BY:

CHECKED BY:


APPROVED BY:

	MATERIALS					
CODE	DESCRIPTION	MANUFACTURER	MODEL			
AID	4# AID CAD					
AIR ALU	1" AIR GAP CLEAR ANODIZED ALUMINUM, MULLION TYP					
BK CF-1	THIN BRICK FINISH CONCRETE FOUNDATION, SEE STRUCTURAL	PINE HALL BRICK,	BROWNS FERRY SEE STRUCTURAL			
CMU2	SPLIT RUNNING CMU, 4" THICK NOMINAL, COLOR GREY CMU, 8" NOMINAL	YORK BUILDING PRODUCTS	SPLIT FACE CMU COLOR 518 FLINT			
FL-1	CONCRETE PAD, BROOM FINISH -					
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GR-2 GRD	THIN MORTAR MTL SCREEN					
GYP2	5/8" GYP. BD SEE WALL DET &					
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SH-1	5/8" EXTERIOR GRADE PLYWOOD SHEATHING					
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SH-R	USG SHEETROCK 5/8" PANEL (UL AR)	USG	USG Sheetrock Brand 5/8" panel (UL AR)			
ST2 STD-3	PRE CAST SILL, COLOR LIMESTONE 3 1/2" DEEP 20 ga. STEEL STUDS W/ 3" MINERAL WOOL BATT INSULATION 6in DEEP, 25ga, SPACED MAX 24IN	STONECAST	LIMESTONE			
	O.C., W/ FIBERGLASS INSULATION					
VN-1 VN-2	BLACK VINYL RED VINYL					
VN-3	WHITE VINYL		0000 405 0015 =::			
VN-4	YELLOW VINYL		3630-125 GOLDEN YELLOW			
WD-1 WD-2	WOOD SLATS PRESSURE TREATED PINE OR EQUIVALENT					
WD-3	WOOD SLATS					

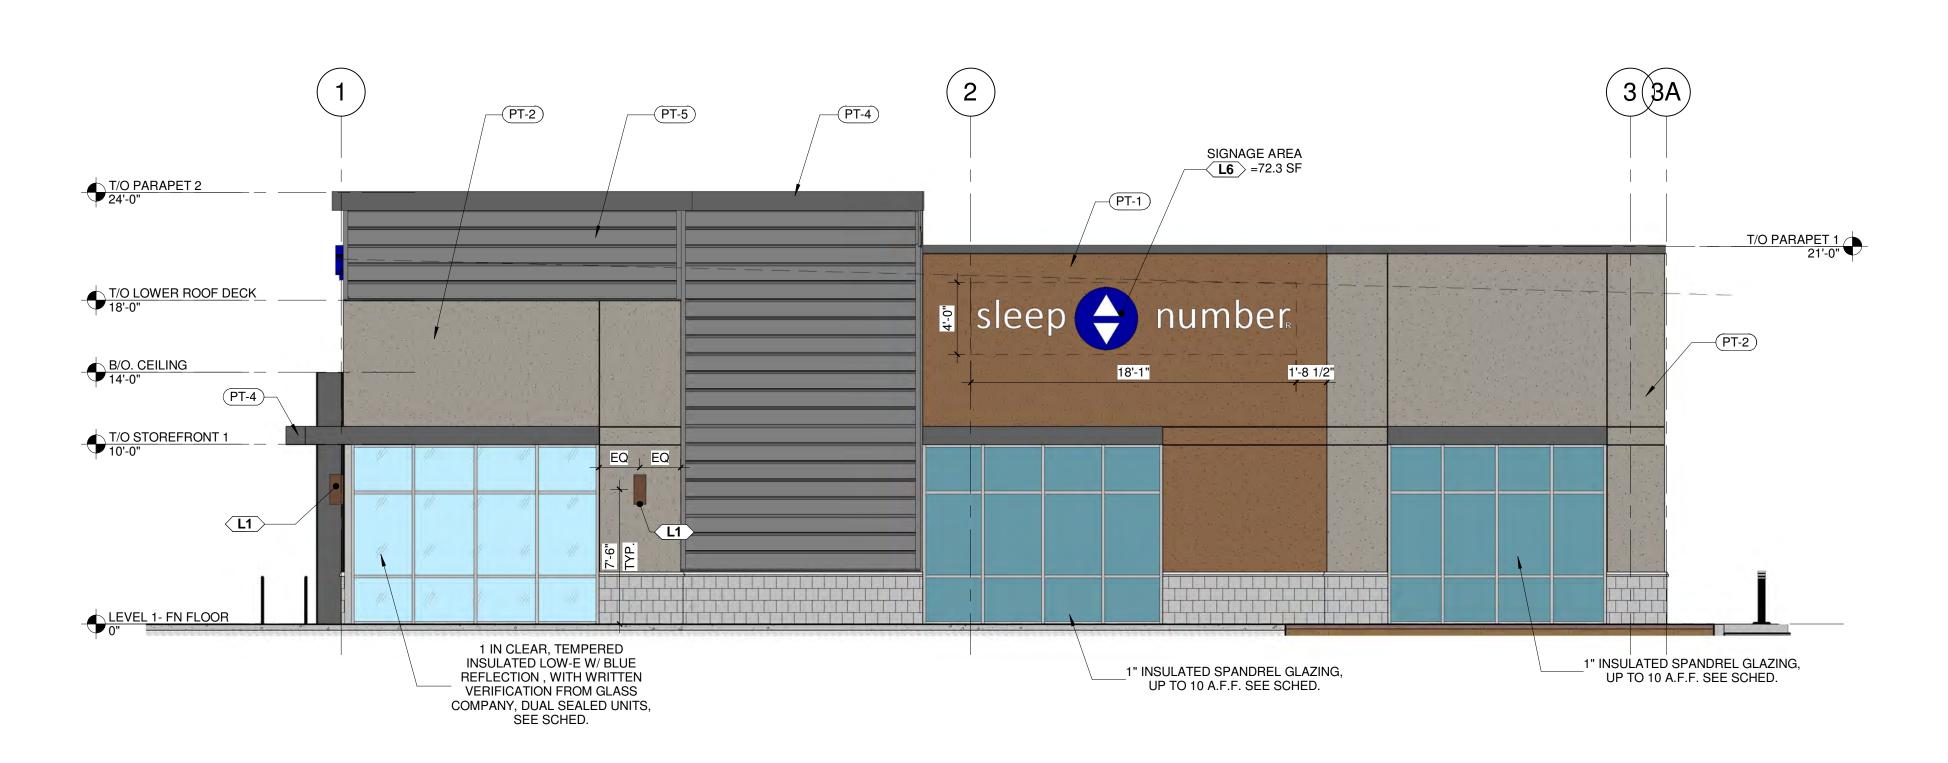

3 SOUTH ELEVATION SCALE: 3/16" = 1'-0"

4 EAST ELEVATION
SCALE: 3/16" = 1'-0"

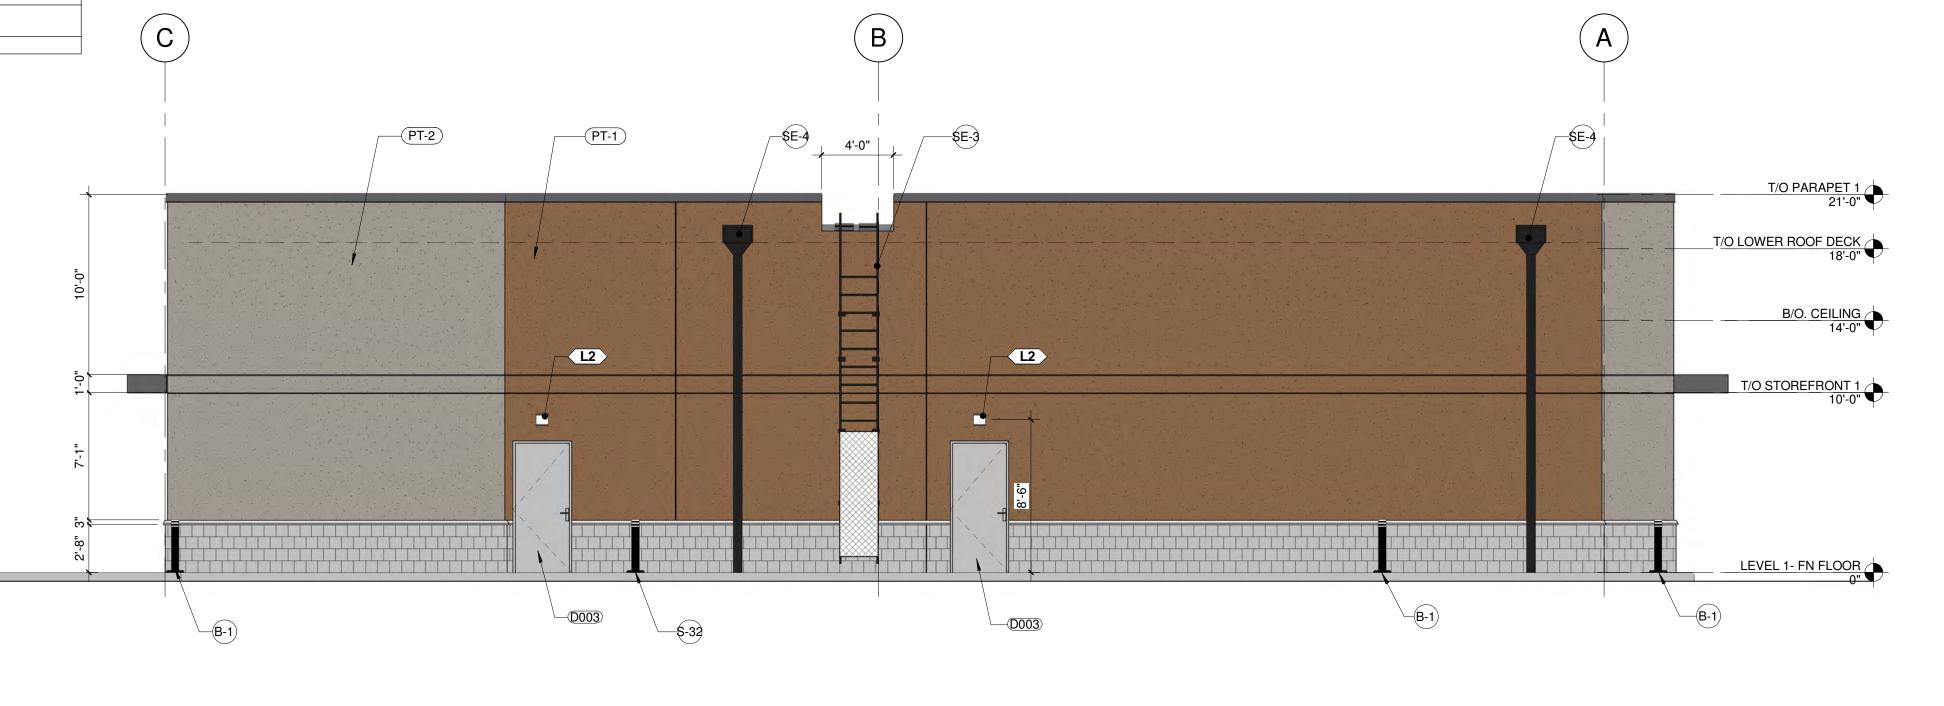

EXTERIOR ELEVATION NOTES

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Client

Project

Consultant

404 S. Wells Street, 3rd Floor, Chicago, IL 60607

Thomas English

Retail Real Estate

THOMAS ENGLISH 725 E. 65TH STREET, STE 300

INDIANAPOLIS, IN 46220

PROPOSED RETAIL

DEVELOPMENT

1961 S. VAL VISTA DR

MESA, AZ 85204

Municipal Approval Stamps

GENERAL KEYNOTES

- B-1 NON-ILLUMINATED BOLLARD
- C10 6" DIAMETER STEEL CONCRETE FILLED PIPE BOLLARD, SEE STRUCTURAL C15 DERO HOOP BIKE "U" RACK, 14.5"x34"x1 5/8", 12
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- DUAL SEALED UNITS.
- IG-3 1" INSULATED SPANDREL GLAZING L1 OUTDOOR WALL SCONCE, FLUSH MOUNT, SEE
- ELECTRICAL
- L2 OUTDOOR WALL SCONCE OVER SERVICE DOOR, SEE ELECTRICAL
- L4 HABIT ILLUMINATED SIGN STACKED LOGO L5 HABIT MESA STANDARD ILLUMINATED LOGO
- L6 SLEEP NUMBER STANDARD LOGO
- L-A SITE POLE LIGHTING TYPE A SEE ELECTRICAL
- SHEETS FOR SPECS L-EX EXISTING SITE POLE, NEW LOCATION - SEE
- ELECTRICAL M1 RTU#1, TYPICAL RTU LOCATION SHOWN - REFER
- TO TENANT CONSTRUCTION DOCUMENTS FOR EXACT LOCATION OF ALL ROOF EQUIPMENT AND PENETRATION.
- M-7 AIR CURTAIN AT DRIVE-THRU WINDOW, SEE RCP NOTE #4 AND M2-01 FOR SPECS
- P-1 SINGLE PARKING, DIM 9'x18', REFLECTIVE WHITE
- P-2 SINGLE PARKING, DIM 9'x16', REFLECTIVE WHITE
- P-3 ADA PARKING, DIM 8'x18', REFLECTIVE WHITE
- PL-1 CREEPIN JUNNIPER
- PL-2 HYDRANGEA PL-3 STAR JASMINE
- S-1 STOP SIGN AND PAINTED BAR, WHITE LEGEND
- RED BACKGROUND S-2 TURN ARROW, REFLECTIVE WHITE PAINT
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- SE-5 1'x1' ROOF WALKWAY PADS
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- ST-1 BEARING STRUCTURE, SEE STRUCTURAL W1 COMMERCIAL, DOUBLE SLIDE THERMAL ALUMINUM WINDOW

02/05/2018 ZONING/ DESIGN REVIEW

PREPARED OR APPROVED BY ME, AND THAT I AM A

DULY LICENSED ARCHITECT UNDER THE LAWS OF

THE STATE OF ARIZONA, LICENSE NUMBER 59402.

11/20/2017 INITIAL ISSUE NO. DATE REVISIONS/ISSUANCES


I CERTIFY THAT THESE DOCUMENTS WERE

PROFESSIONAL CERTIFICATION:

FOR PERMIT/ FOR BID

DATE:	02/05/2018
PROJECT NUMBER:	DXU#17-264
SCALE:	3/16" = 1'-0"
DRAWN BY:	DTE
CHECKED BY:	BG
APPROVED BY:	ES

EXTERIOR ELEVATIONS

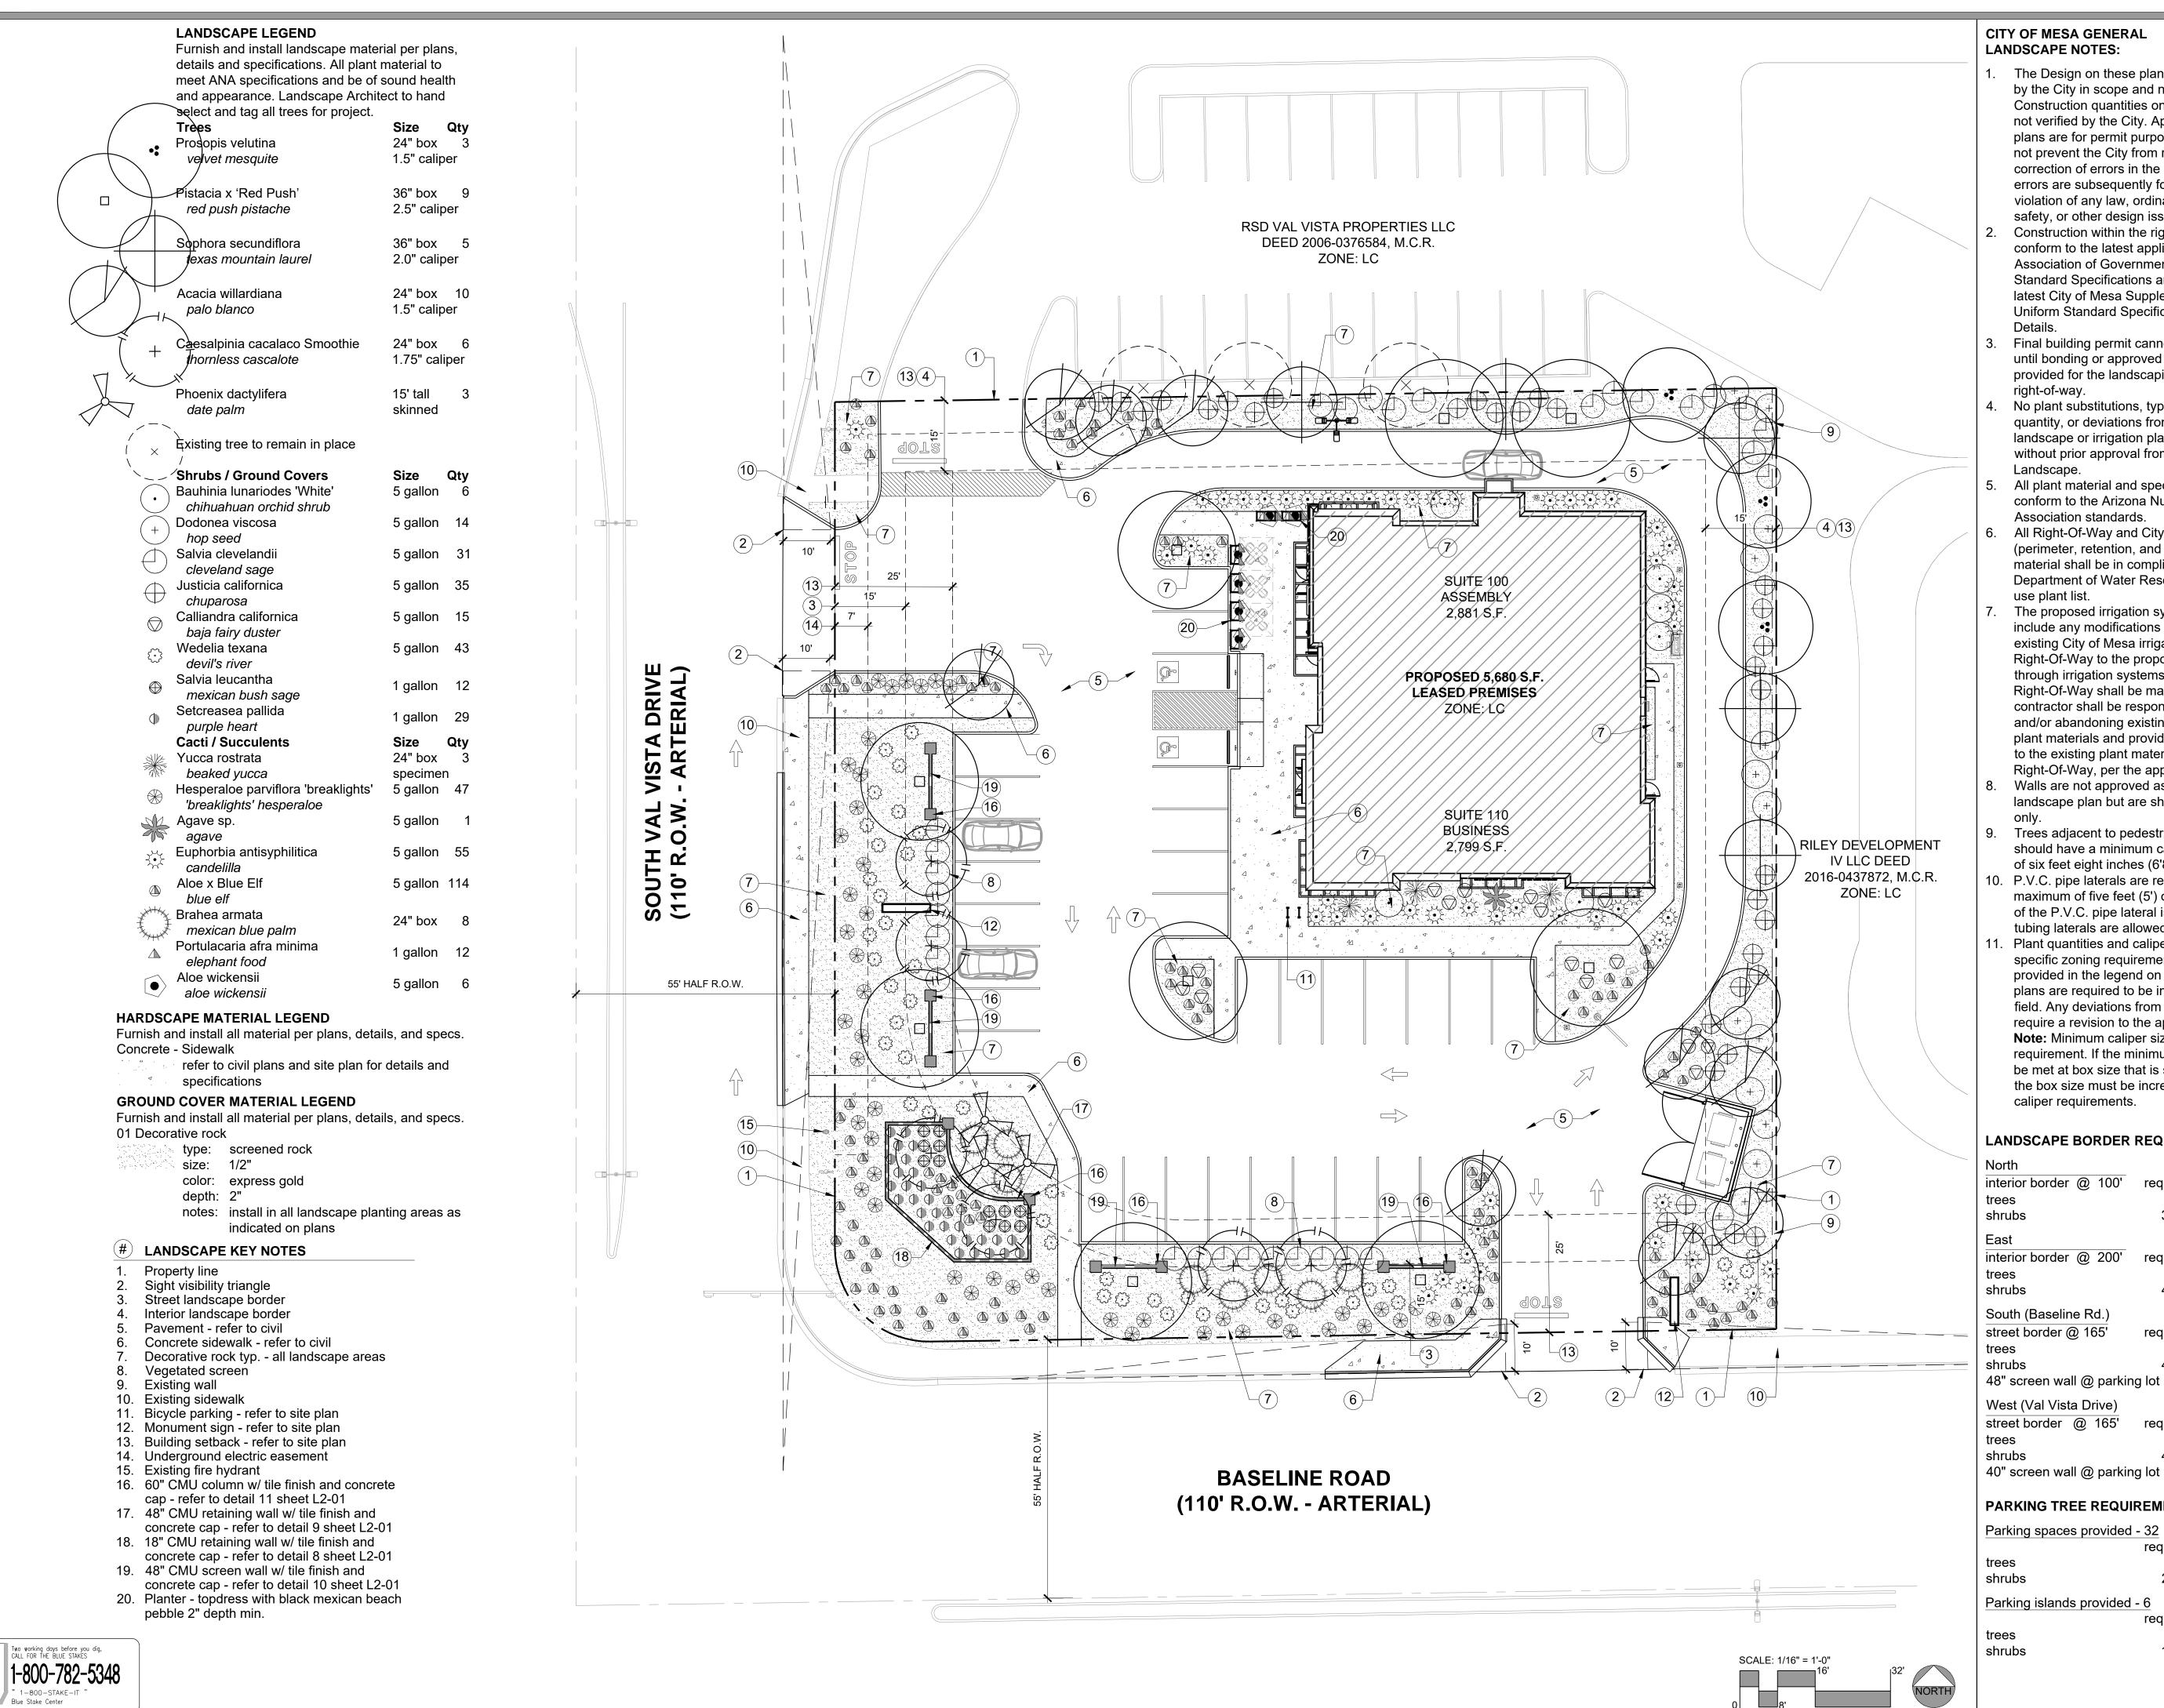

CITY OF MESA GENERAL LANDSCAPE NOTES:

- The Design on these plans is only approved by the City in scope and not in detail. Construction quantities on these plans are not verified by the City. Approval of these plans are for permit purposes only and shall not prevent the City from requiring correction of errors in the plans where such errors are subsequently found to be in violation of any law, ordinance, health, safety, or other design issues.
- Construction within the right-of-way shall conform to the latest applicable Maricopa Association of Governments (MAG) Uniform Standard Specifications and Details and the latest City of Mesa Supplement to the MAG Uniform Standard Specifications and
- Final building permit cannot be obtained until bonding or approved assurances are provided for the landscaping within the right-of-way.
- No plant substitutions, type, size, or quantity, or deviations from the approved landscape or irrigation plans, are allowed without prior approval from the City of Mesa Landscape.
- All plant material and specifications shall conform to the Arizona Nurseryman Association standards.
- All Right-Of-Way and City required (perimeter, retention, and parking) plant material shall be in compliance with the Department of Water Resources low water use plant list.
- The proposed irrigation system shall include any modifications required to tie the existing City of Mesa irrigation system in Right-Of-Way to the proposed system. All through irrigation systems in the Right-Of-Way shall be maintained. The contractor shall be responsible for capping and/or abandoning existing irrigation to plant materials and providing new irrigation to the existing plant material, in Right-Of-Way, per the approved plan.
- Walls are not approved as part of the landscape plan but are shown for reference 9. Trees adjacent to pedestrian walkways
- should have a minimum canopy clearance of six feet eight inches (6'8"). 10. P.V.C. pipe laterals are required. A
- maximum of five feet (5') of poly tubing off of the P.V.C. pipe lateral is allowed. No poly tubing laterals are allowed. 11. Plant quantities and caliper sizes, per the
- specific zoning requirements for this site, provided in the legend on the approved plans are required to be installed in the field. Any deviations from the plan will require a revision to the approved plan. **Note:** Minimum caliper size is a zoning requirement. If the minimum caliper cannot be met at box size that is specified, then the box size must be increased to meet caliper requirements.

LANDSCAPE BORDER REQUIREMENTS

North		
interior border @ 100'	required	provided
trees	6	6
shrubs	35	35
East		
interior border @ 200'	required	provided
trees	6	6
shrubs	40	40
South (Baseline Rd.)		
street border @ 165'	required	provided
trees	7	7
shrubs	40	40
48" screen wall @ parkin	g lot	
West (Val Vista Drive)		
street border @ 165'	required	provided
trees	7	7
shrubs	40	40
40" " 0 11		

DADKING THEE DECLINEMENTS

PARKING TREE REQUIREMENTS		
Parking spaces provided	- 32	
	required	provided
trees	4	4
trees shrubs	24	24
Parking islands provided	- 6	
	required	provided

LANDSCAPE PLAN

18

NOT FOR CONSTRUCTION, NOT FOR BIDDING - FOR AGENCY REVIEW AND APPROVAL ONLY. LANDSCAPE AND IRRIGATION PLANS ARE NOT TO BE USED FOR LANDSCAPE, MASONRY, IRRIGATION, BIDDING OR CONSTRUCTION. ARC STUDIOS, INC. RETAINS ALL RIGHTS TO LANDSCAPE AND IRRIGATION PLANS. LANDSCAPE AND IRRIGATION PLANS MAY NOT BE REPRODUCED WITHOUT PRIOR APPROVAL BY ARC STUDIOS, INC.

1-800-STAKE-IT ' Blue Stake Center

ARCHITECTS P: 312 955 0334 . dxuarch.com ILLINOIS DESIGN FIRM # 184.006688

Municipal Approval Stamps

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THOMAS ENGLISH 725 E. 65TH STREET, STE 300 INDIANAPOLIS, IN 46220

Retail Real Estate

Client

PROPOSED RETAIL DEVELOPMENT

> 1961 S. VAL VISTA DR MESA, AZ 85204

Project



Consultant

NO. DATE REVISIONS/ISSUANCES

PROFESSIONAL CERTIFICATION: I CERTIFY THAT THESE DOCUMENTS WERE PREPARED OR APPROVED BY ME, AND THAT I AM A DULY LICENSED ARCHITECT UNDER THE LAWS OF THE STATE OF ARIZONA, LICENSE NUMBER 59402.



FOR PERMIT/ FOR BID

DATE: 2/05/2018 01-17103 PROJECT NUMBER: As indicated SCALE: DJR DRAWN BY: ERB CHECKED BY: ERB APPROVED BY:

IRRIGATION LEGEND

furnish and install all material per plans, details, and specifications irrigation source / point of connection - irrigation meter - 5/8" (refer to civil water plans)

reduced pressure backflow preventer - watts u009 - 1" w/ enclosure

_ _ irrigation mainline - sch. 40 pvc 1-1/2" w/ sch. 80 fittings, 2hr pressure test at 150 psi irrigation controller - toro evolution controller w/ smart

connect and weather sensor, evo-4-od-8-sc, evo-ws remote control valve & filter - valve - irritrol 700 series, 700-1; filter - rain bird rby-100-150mx

___ irrigation sleeve - class 200 pvc - 4" mainlines and multiple lines 2" single line and controller wiring

tree line - sch. 40 pvc - 3/4" unless otherwise shown

_ _ _ shrub line - sch. 40 pvc - 3/4" unless otherwise shown

pressure regulator - senniger - pmr-30-mf

multi-outlet xeri-bug emitters rain bird - (6) 1gph and 2 gph ports - refer to emitter schedule

single-port emitters - install rain bird xeri-bug xbt-10 and xbt-20 - refer to emitter schedule

IRRIGATION VALVE SCHEDULE

Valve	Size	Type	Valve	Size	Туре
A-1	1"	tree	A-5	1"	shrub
A-2	1"	shrub	A-6		not used
A-3	1"	raised planter	A-7		not used
A-4	1"	raised planter	A-8		not used
VALVE	SCHEDI	II E NOTES:			

VALVE SCHEDULE NOTES:

plant material for establishment.

1. (M) multi-port emitter, (s) single-port emitter. Contractor may select to provide multi-port emitters for shrub plant material. Contractor shall adjust controller for the proposed emitter schedule and provide watering to promote healthy growth of

EMITTER SCHEDULE

EMITTER SCHEDULE Trees	Туре	Outlets	Gph outlet	Gph plant
Prosopis velutina velvet mesquite	m	5	2.0	10.0
Pistacia x 'Red Push' red push pistache	m	6	2.0	12.0
Sophora secundiflora texas mountain laurel	m	4	2.0	8.0
Acacia willardiana palo blanco	m	4	2.0	8.0
Caesalpinia cacalaco Smoothie thornless cascalote	m	4	2.0	8.0
Phoenix dactylifera date palm	m	4	2.0	8.0
Shrubs / Ground Covers	Type	Outlets	Gph outlet	Gph plant
Bauhinia lunariodes 'White' chihuahuan orchid shrub	s/m	3	2.0	6.0
Dodonea viscosa hop seed	s/m	2	2.0	4.0
Salvia clevelandii cleveland sage	s/m	2	2.0	4.0
Justicia californica chuparosa	s/m	2	1.0	2.0
Calliandra californica baja fairy duster	s/m	2	1.0	2.0
Wedelia texana devil's river	s/m	1	1.0	1.0
Salvia leucantha mexican bush sage	s/m	2	2.0	4.0
Setcreasea pallida purple heart	s/m	1	1.0	1.0
Cacti / Succulents	Type	Outlets	Gph outlet	Gph plant
Yucca rostrata beaked yucca	s/m	2	1.0	2.0
Hesperaloe parviflora 'breaklights' 'breaklights' hesperaloe	s/m	2	1.0	2.0
Agave sp. agave	s/m	1	0.5	0.5
Euphorbia antisyphilitica candelilla	s/m	1	0.5	0.5
Aloe x Blue Elf blue elf	s/m	1	0.5	0.5
Brahea armata mexican blue palm	s/m	2	2.0	4.0
Portulacaria afra minima elephant food	s/m	1	0.5	0.5
Aloe wickensii aloe wickensii	s/m	1	0.5	0.5

(#) IRRIGATION KEY NOTES

Property line


1-800-782-5348

Irrigation source

Irrigation mainline Backflow preventer

5. Irrigation sleeve - refer to paving & grading

6. Irrigation controller

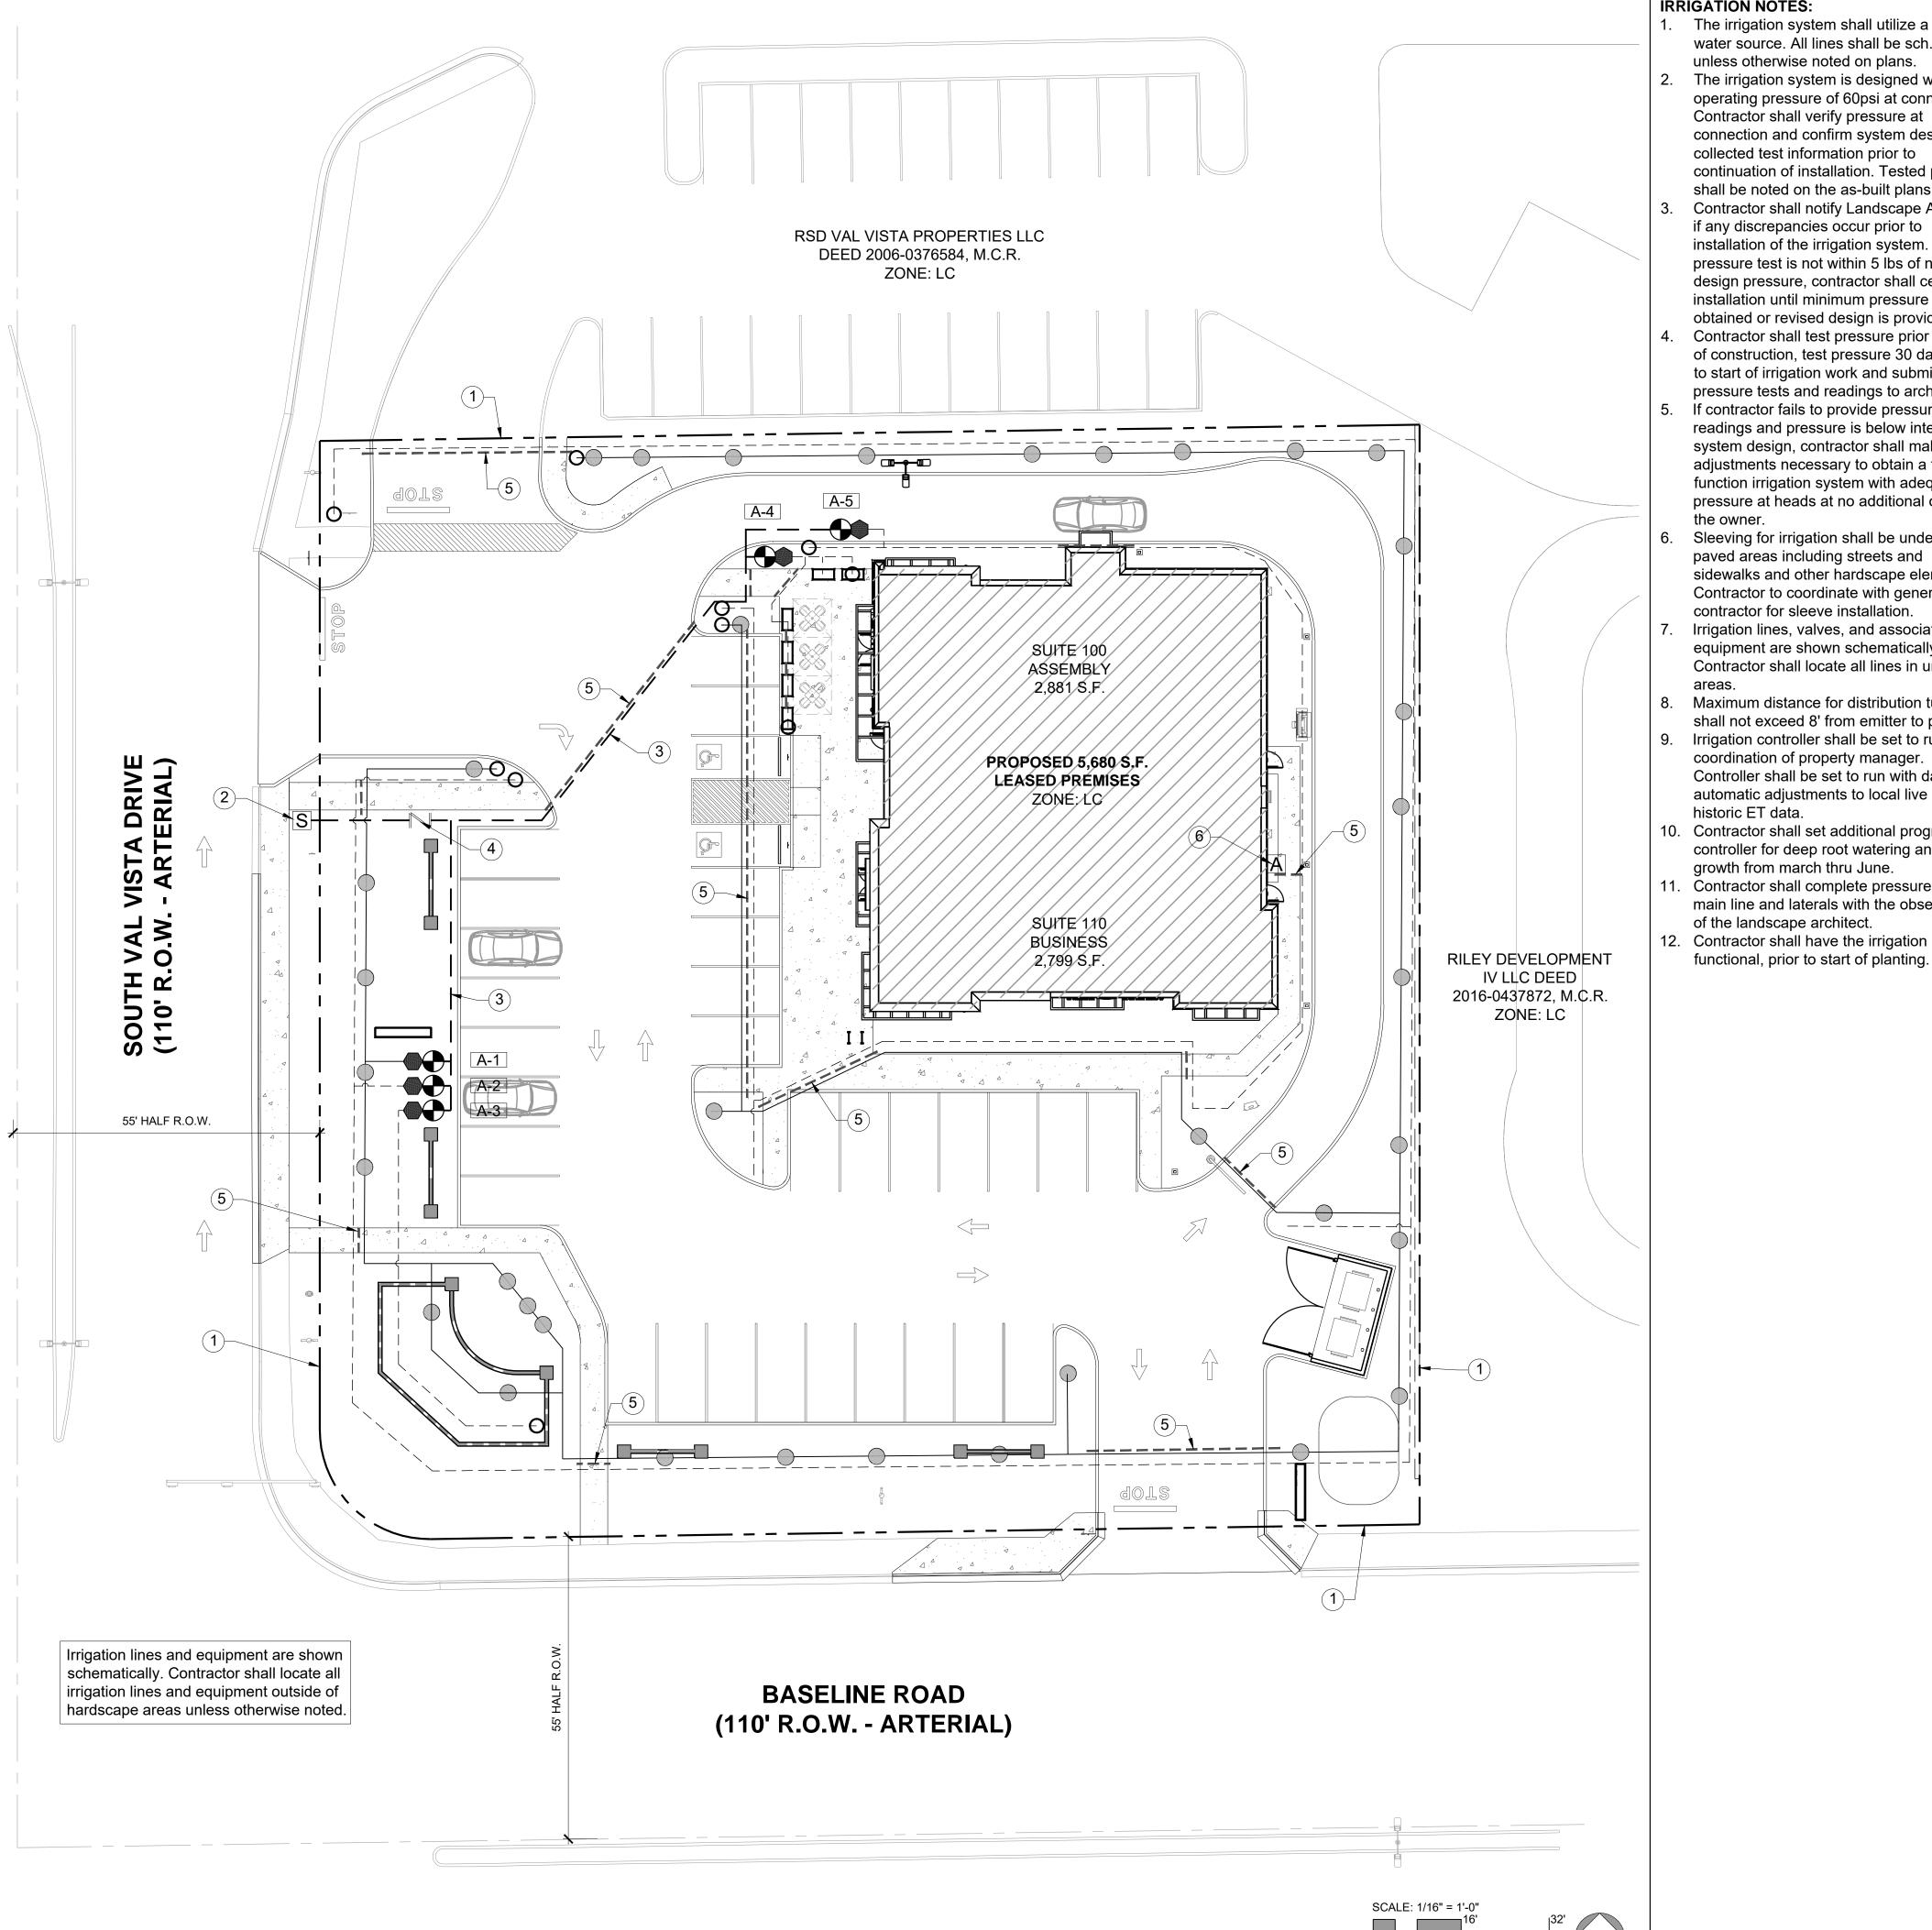

IRRIGATION NOTES:

1. The irrigation system shall utilize a potable water source. All lines shall be sch. 40 pvc unless otherwise noted on plans.

The irrigation system is designed with an operating pressure of 60psi at connection. Contractor shall verify pressure at connection and confirm system design with collected test information prior to continuation of installation. Tested pressure shall be noted on the as-built plans.

Contractor shall notify Landscape Architect if any discrepancies occur prior to installation of the irrigation system. If the pressure test is not within 5 lbs of noted design pressure, contractor shall cease installation until minimum pressure is obtained or revised design is provided.

Contractor shall test pressure prior to start of construction, test pressure 30 days prior to start of irrigation work and submit pressure tests and readings to architect.

If contractor fails to provide pressure test readings and pressure is below intended system design, contractor shall make adjustments necessary to obtain a fully function irrigation system with adequate pressure at heads at no additional cost to the owner.

Sleeving for irrigation shall be under all paved areas including streets and sidewalks and other hardscape elements. Contractor to coordinate with general contractor for sleeve installation. Irrigation lines, valves, and associated

equipment are shown schematically. Contractor shall locate all lines in unpaved Maximum distance for distribution tubing

shall not exceed 8' from emitter to plant. Irrigation controller shall be set to run per coordination of property manager. Controller shall be set to run with daily automatic adjustments to local live ET or

historic ET data. 10. Contractor shall set additional programs on controller for deep root watering and plant growth from march thru June.

11. Contractor shall complete pressure test of main line and laterals with the observation of the landscape architect.

functional, prior to start of planting.

Municipal Approval Stamps



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THOMAS ENGLISH 725 E. 65TH STREET, STE 300 INDIANAPOLIS, IN 46220

Client

PROPOSED RETAIL DEVELOPMENT

> 1961 S. VAL VISTA DR MESA, AZ 85204


Project

Consultant



DATE REVISIONS/ISSUANCES PROFESSIONAL CERTIFICATION: I CERTIFY THAT THESE DOCUMENTS WERE PREPARED


OR APPROVED BY ME, AND THAT I AM A DULY LICENSED ARCHITECT UNDER THE LAWS OF THE STATE OF

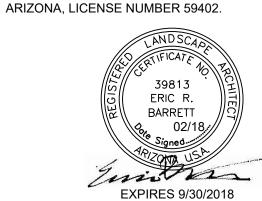

FOR PERMIT/ FOR BID

DATE:	2/05/2018
PROJECT NUMBER:	01-1710
SCALE:	As indicated
DRAWN BY:	DJF
CHECKED BY:	ERI
APPROVED BY:	ERI

IRRIGATION PLAN

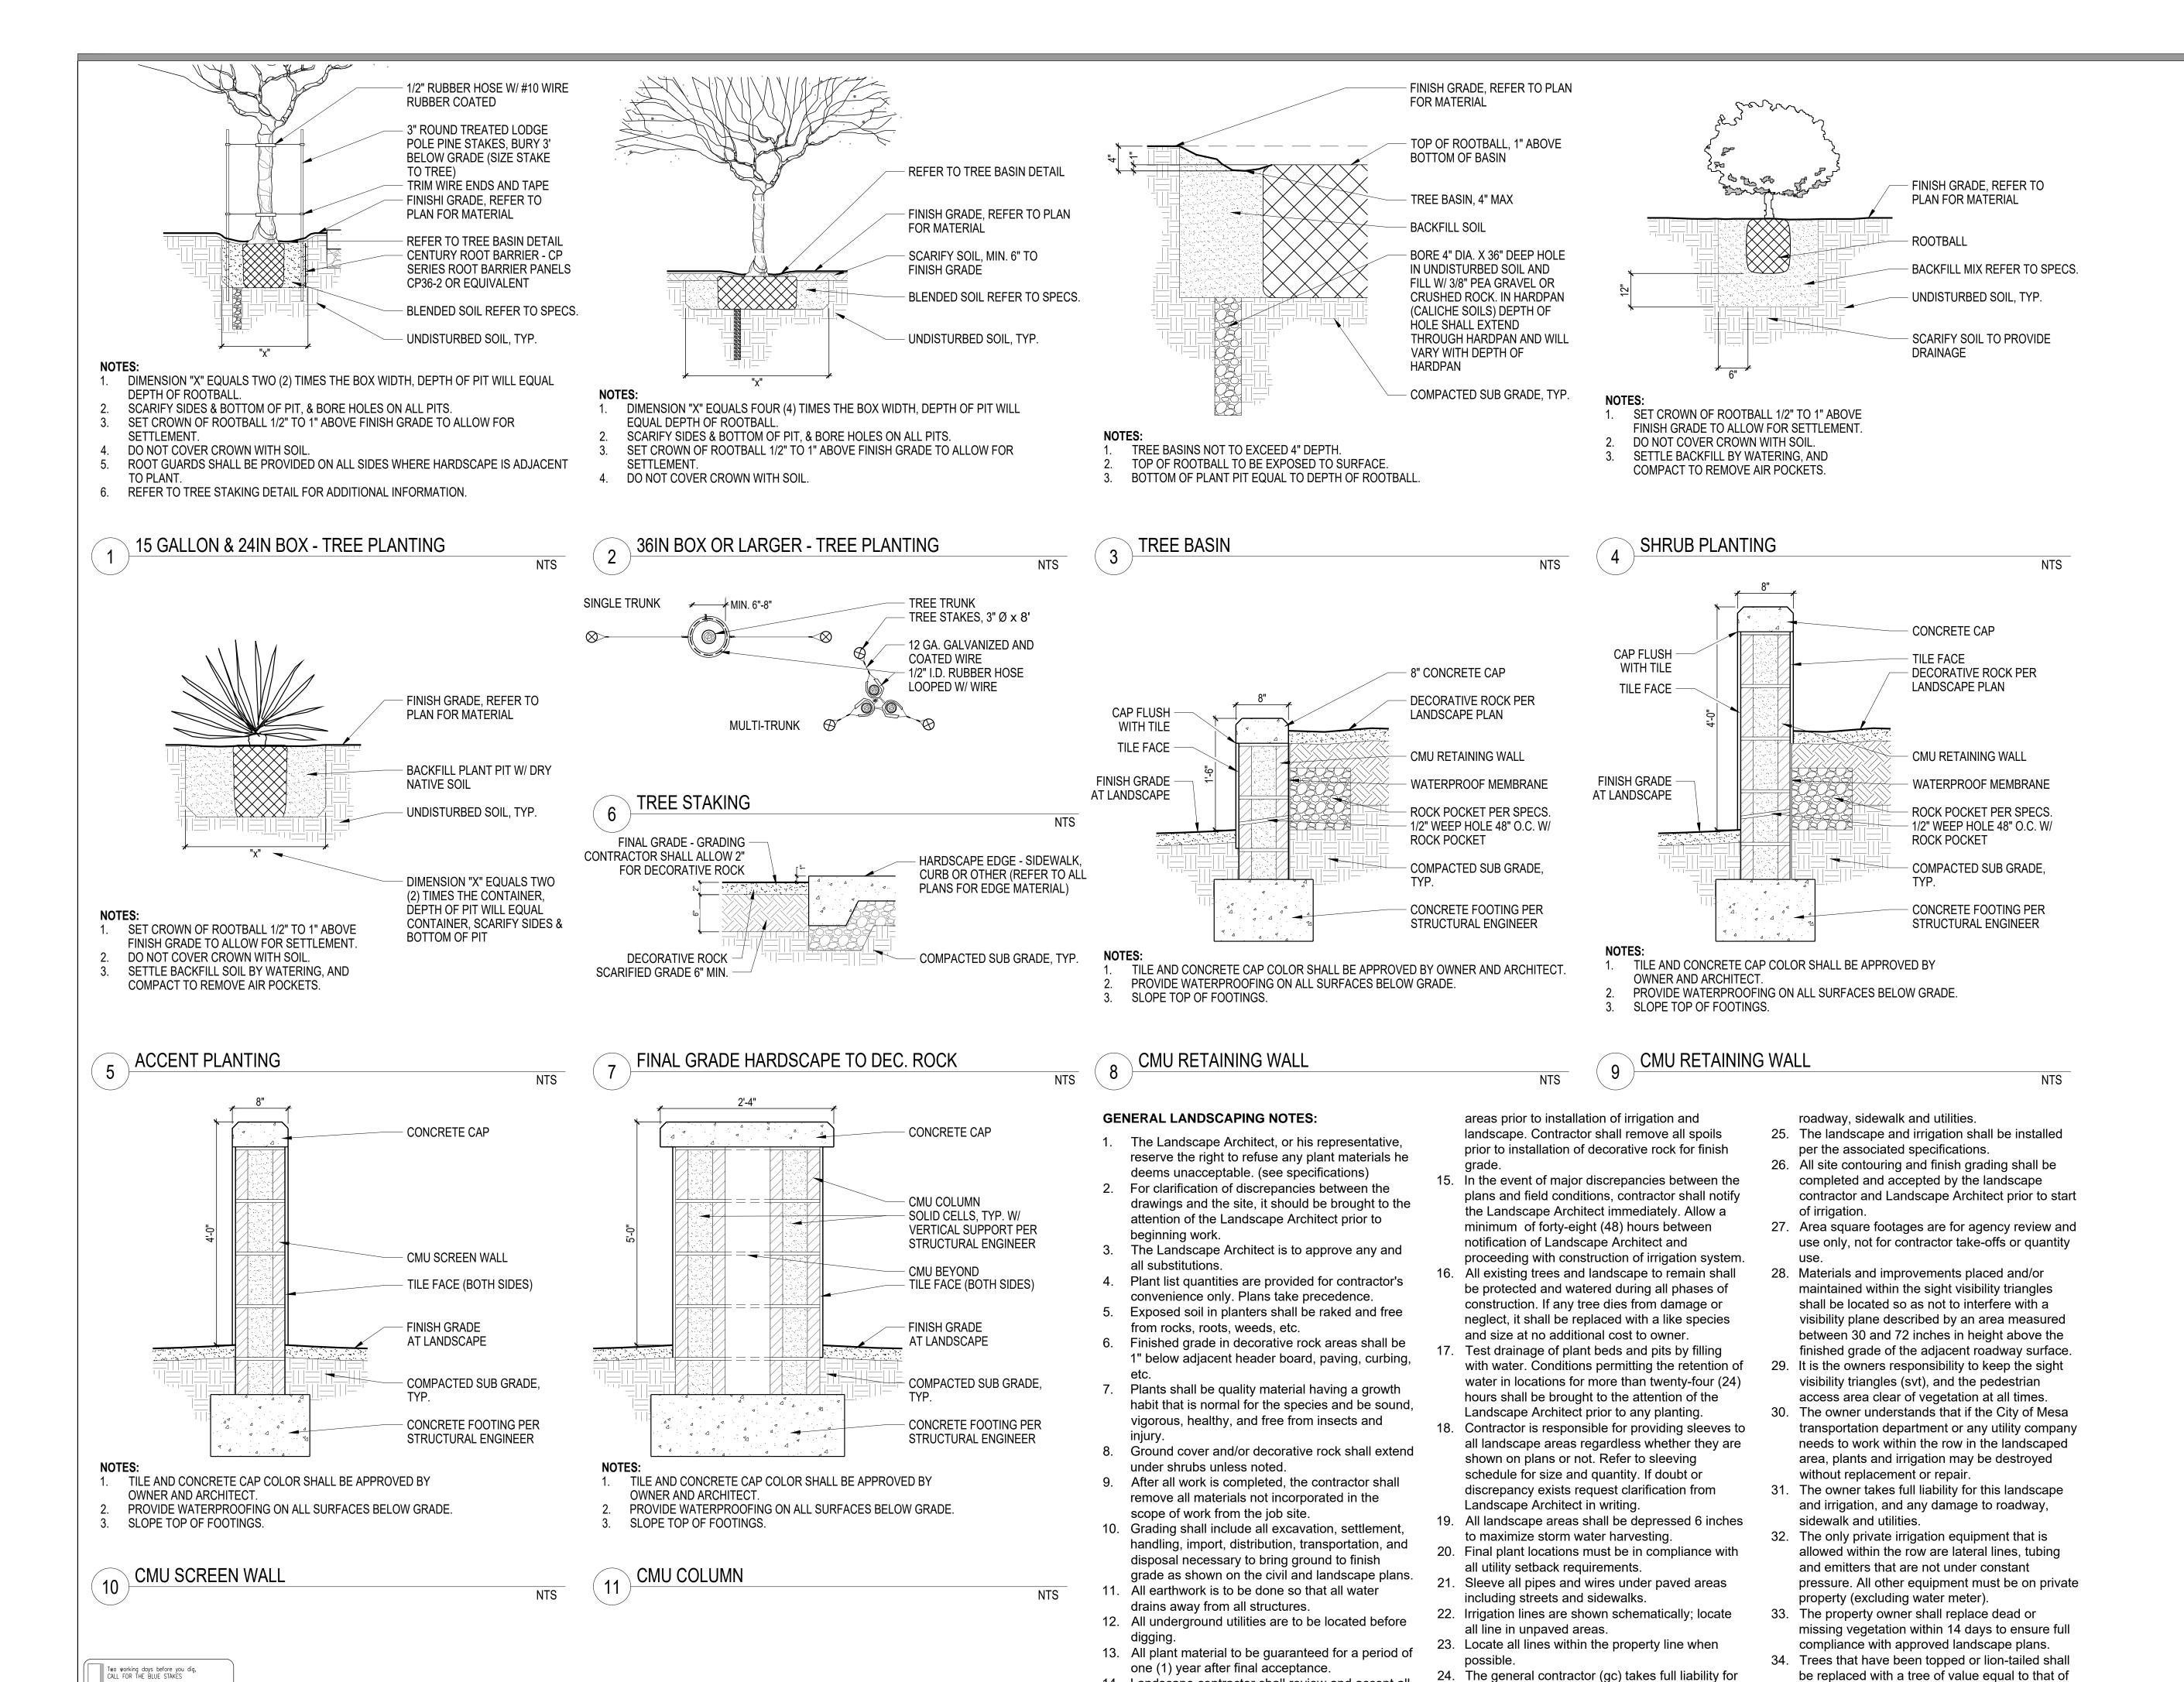

14. Landscape contractor shall review and accept all

rough, and finish grading on all landscaped

this landscape and irrigation, and any damage to

the tree prior to the improper pruning.

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1961 S. VAL VISTA DR MESA, AZ 85204

Project



Consultant

NO. DATE REVISIONS/ISSUANCES

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OR APPROVED BY ME, AND THAT I AM A DULY LICENSED
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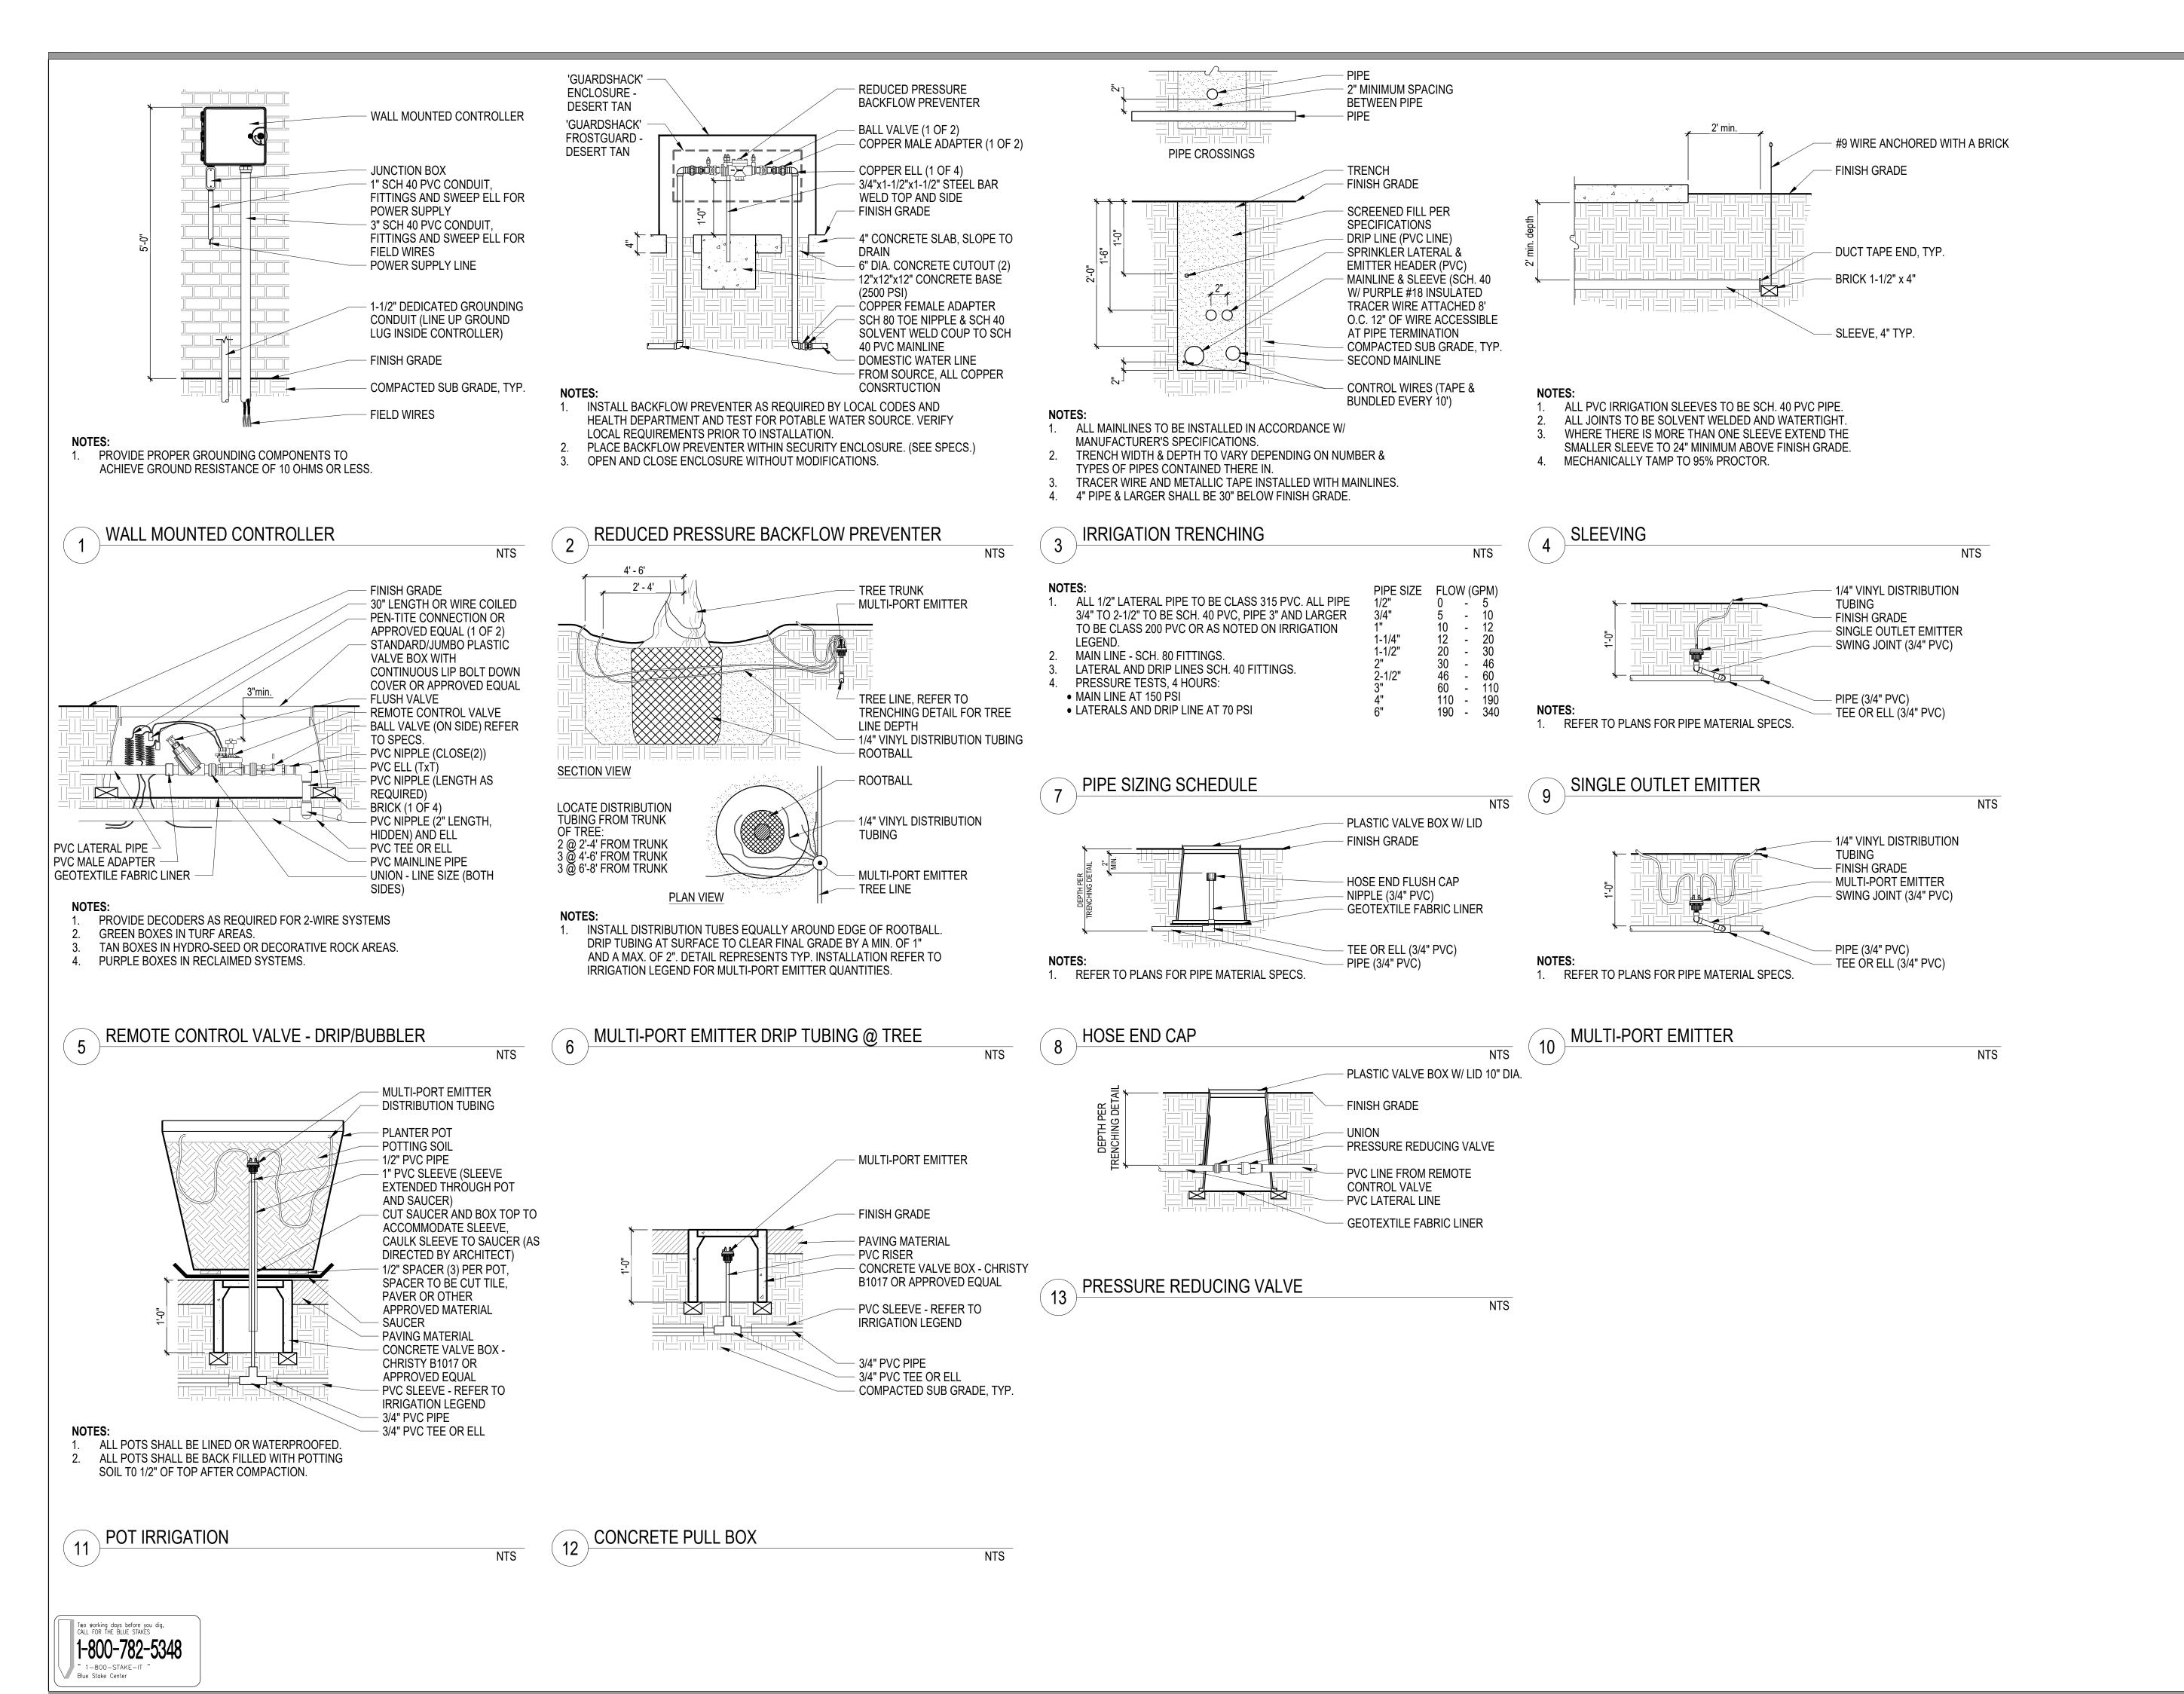
DATE:	2/05/201
PROJECT NUMBER:	01-1710
SCALE:	As indicate
DRAWN BY:	DJF
CHECKED BY:	ERI
APPROVED BY:	ER

LANDSCAPE DETAILS

L2-01

1-800-782-5348

" 1-800-STAKE-IT ' Blue Stake Center





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PROPOSED RETAIL DEVELOPMENT

1961 S. VAL VISTA DR MESA, AZ 85204

Project

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SEAL


FOR PERMIT/ FOR BID

PROJECT NUMBER: SCALE: DRAWN BY: CHECKED BY: APPROVED BY:	
SCALE: DRAWN BY:	ERB
SCALE:	ERB
	DJR
PROJECT NUMBER:	As indicated
	01-17103
DATE:	2/05/2018

L2-02

	ZONING	EXISTING	PROPOSED	NOTES
BUILDING:				
FRONT (WEST)	25'	56.29'	90.55'	6 LANE ARTERIAL ROAD
REAR (EAST)	15'	9.46'	25.76'	
SIDE (NORTH)	15'	18.21'	22.23'	
SIDE (SOUTH)	25'	29.69'	93.77'	
PARKING:				
FRONT (WEST)	15'	120.62'	15'	
REAR (EAST)	15'	17'	=	
SIDE (NORTH)	15'	23.57'	-	
SIDE (SOUTH)	15'	33.84'	19.57'	
PARKING TA	BLE:			
FRONT (WEST)		9 STALLS	16 STALLS	
REAR (EAST)		N/A	N/A	
SIDE (NORTH)		N/A	N/A	
SIDE (SOUTH)		N/A	16 STALLS	

SITE PLAN FOR REFERENCE USE ONLY. SEE APPROVED CIVIL SITE PLAN FOR DETAILS

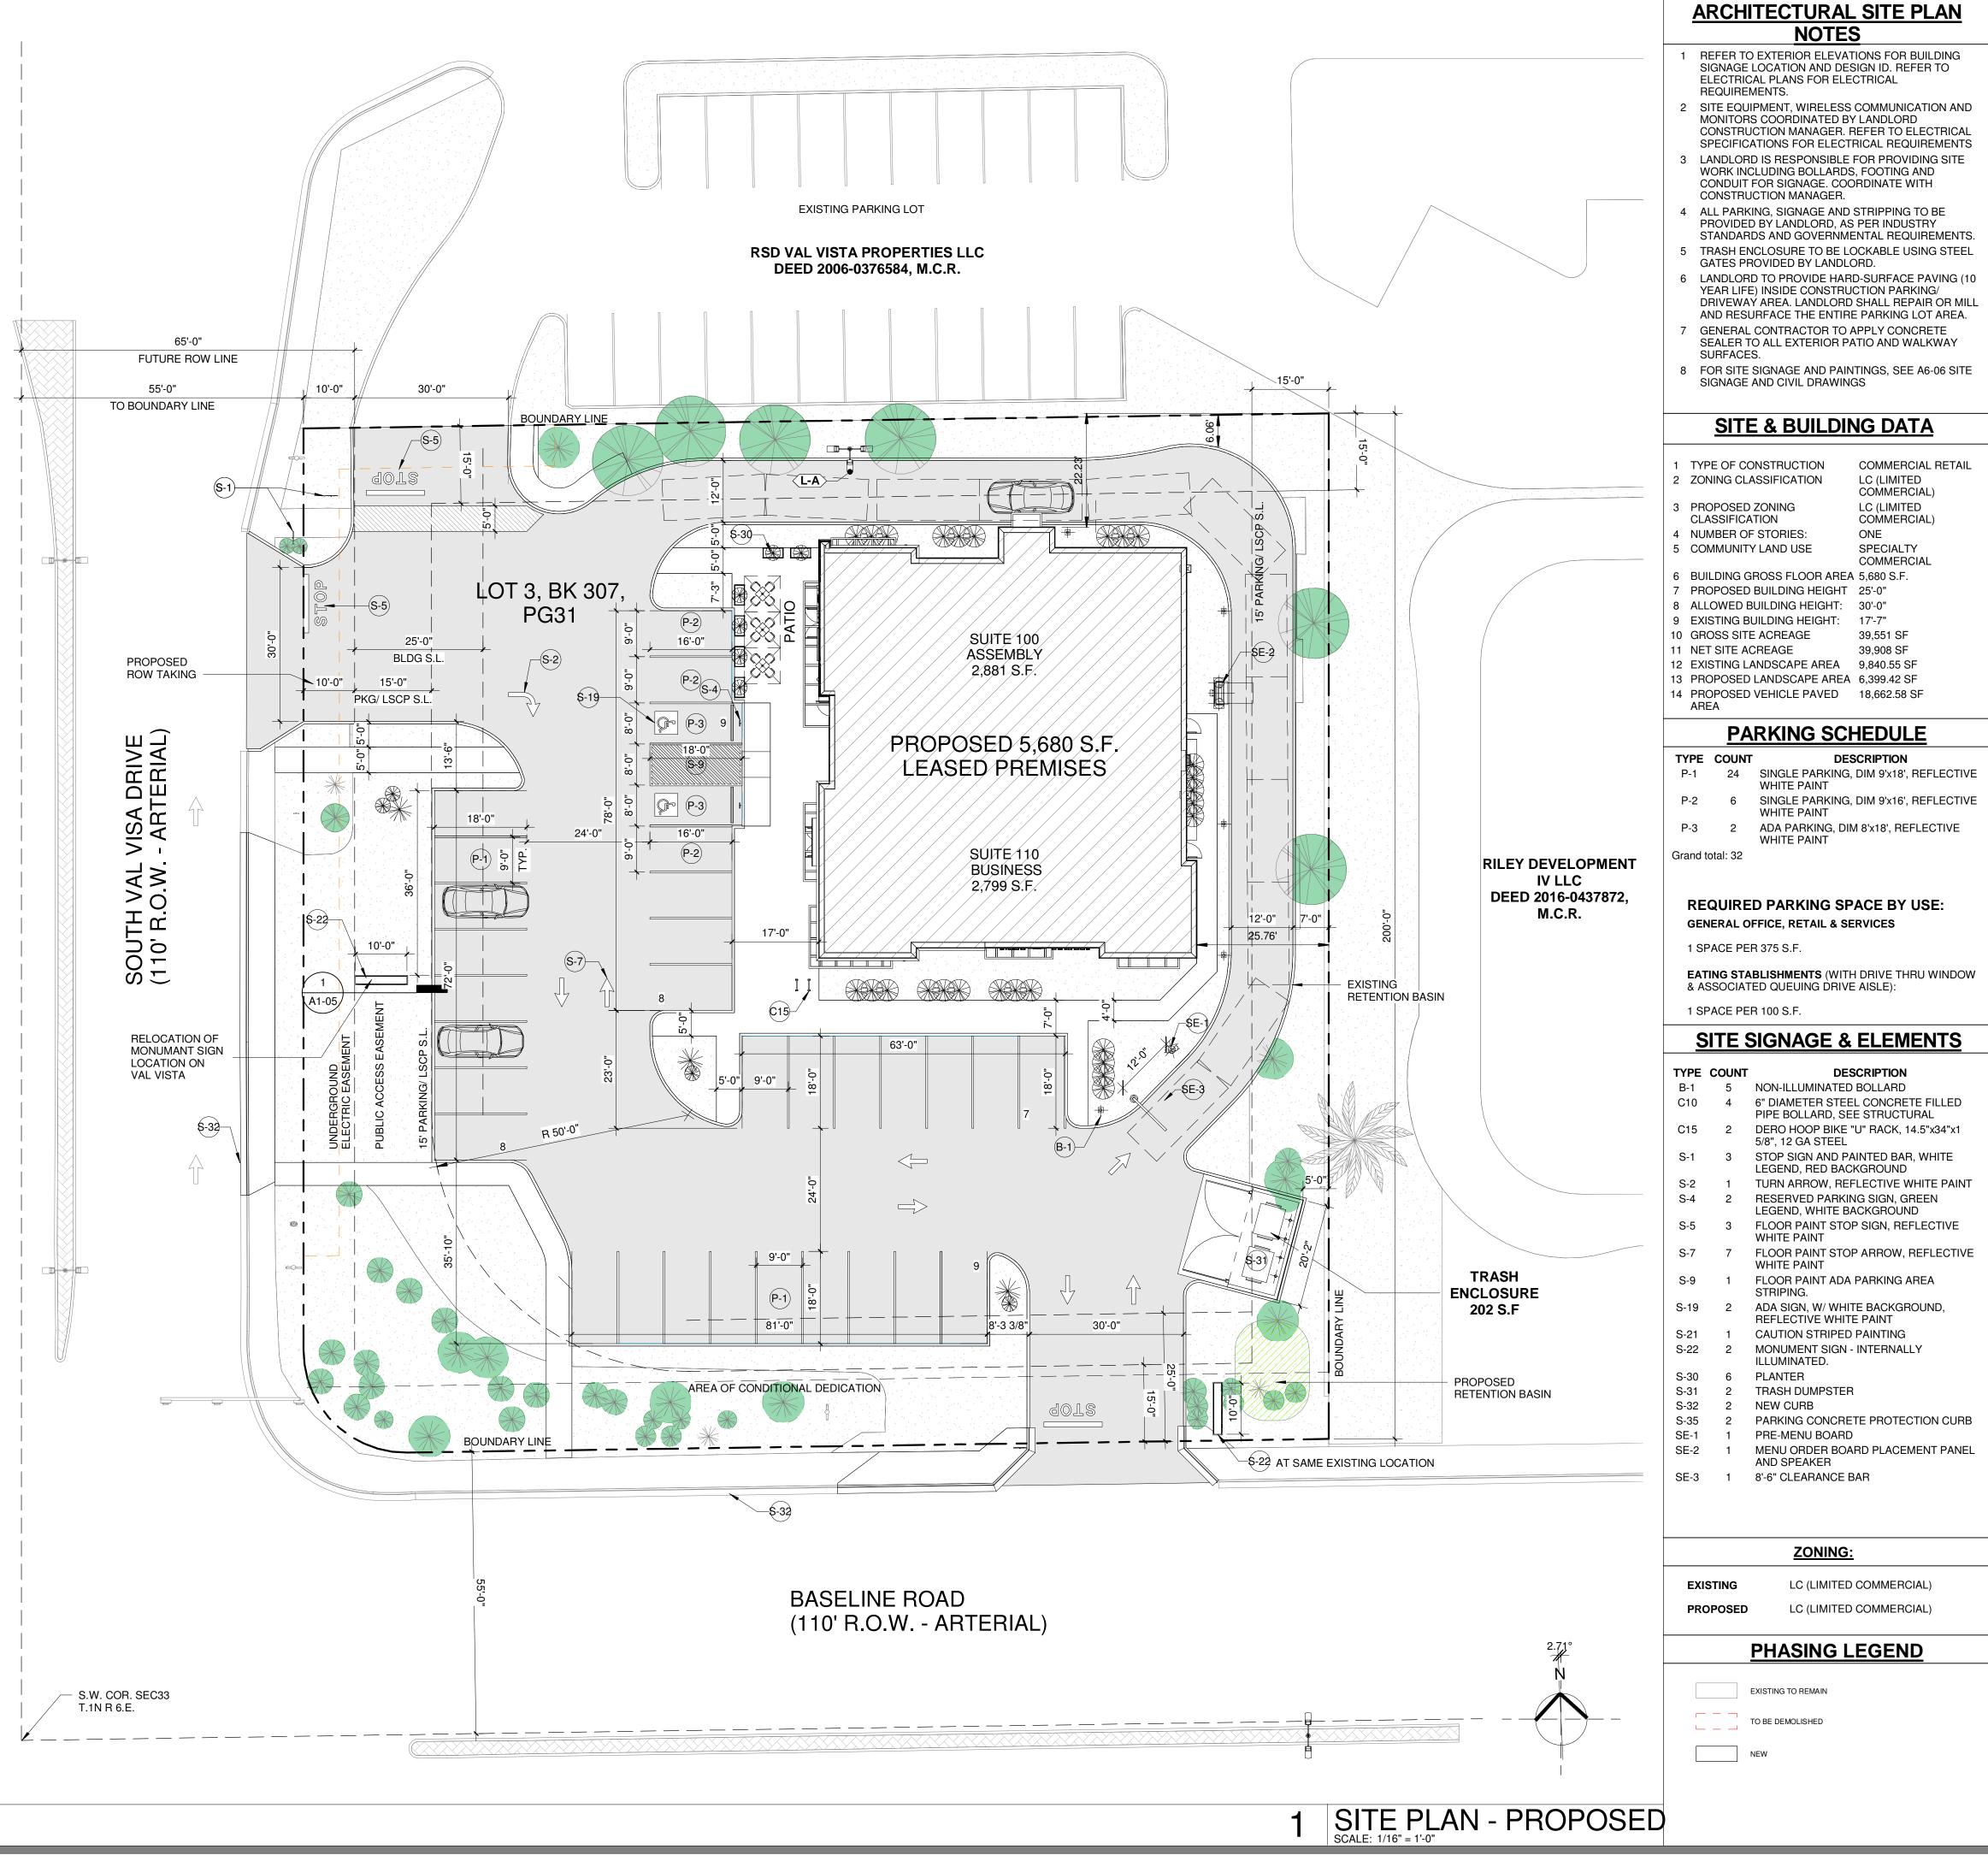

Municipal Approval Stamps

404 S. Wells Street, 3rd Floor, Chicago, IL 60607 P: 312 955 0334 www.dxuarch.com

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Thomas English Retail Real Estate

THOMAS ENGLISH 725 E. 65TH STREET, STE 300

INDIANAPOLIS, IN 46220

Client

PROPOSED RETAIL DEVELOPMENT 1961 S. VAL VISTA DR

MESA, AZ 85204

Project

Consultant

02/05/2018 ZONING/ DEIGN REVIEW 11/20/2017 INITIAL ISSUE NO. DATE REVISIONS/ISSUANCES

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FOR PERMIT/ FOR BID

DATE:	02/05/2018
PROJECT NUMBER:	DXU#17-264
SCALE:	As indicated
DRAWN BY:	DTE
CHECKED BY:	BG
APPROVED BY:	ES

SITE PLAN - PROPOSED





2 SITE - EXISTING +DEMO





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Retail Real Estate

THOMAS ENGLISH 725 E. 65TH STREET, STE 300 INDIANAPOLIS, IN 46220

Client

PROPOSED RETAIL DEVELOPMENT 1961 S. VAL VISTA DR MESA, AZ 85204

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THE STATE OF ARIZONA, LICENSE NUMBER 59402.



SEAL

FOR PERMIT/ FOR BID

DATE:	02/05/2018
PROJECT NUMBER:	DXU#17-264
SCALE:	
DRAWN BY:	DTE
CHECKED BY:	BG
APPROVED BY:	ES
	<u> </u>
SITE - PERSPECTIVES	>

A1-04



Thomas English Retail Real Estate, LLC

725 East 65th Street, Suite 300 | Indianapolis, IN 46220 T: 317-574-7448 www.thomasenglish.com

FOLLOW-UP SUBMITTAL FOR P&Z SUBMITTAL ZON17-00597

DATE: February 5, 2018

PROJECT NAME: 1961 VAL VISTA REDEVELOPMENT

PROJECT NARRAVTIVE:

The site is approximately 0.916 net acres or ±39,906' SF and is currently an operating Circle K gas station. The gas station consists of one building approximately 1,262' SF, ten (10) pumps for refueling under a canopy approximately 17.7' ft. in height and 4,402' SF, and approximately three (3) underground storage tanks for fuel. Prior to implementing our redevelopment plan, all existing improvements will be removed in accordance with Arizona Department of Environmental Quality UST guidelines and procedures. All environmental concerns will be alleviated during this process and a letter from the ADEQ indicating No Further Action (NFA) will be obtained (if required). Once the site has been remediated to standards permissible for commercial development, we proposed to construct a 5,680' SF multi-tenant commercial building with a drive-through for restaurant and general retail uses. The two proposed uses are permitted in the Limited Commercial (C-2) zoning district. and are service restaurant (with drive-thru) and general retail. A total of 32 parking spaces will be provided and 9 stalls for drive-thru stacking.

EXISTING DECLARATION: In response to Staff comments received January 11,2018, it is important to note the existing covenants & restrictions that encumber the property. The site is part of Baseline Commercial Center (Lot 2, according to Book 307 of Maps, Page 31, records of Maricopa County, AZ). As a part of that original development there was a Declaration recorded in 1986 that restricts the future redevelopment of that Lot 2 to fit a building within a specific building area (see attached Exhibit A). Lot 3 of the original Baseline Commercial Center has since been subdivided many times and there are currently 64 APNs and 12 separate land owners (see attached Exhibit A_1). This restricted building area significantly impacts the future redevelopment of the site as it relates to the Mesa 2040 General Plan. It is extremely difficult to formulate a design layout that satisfies all the criteria for the General Plan due to the recorded covenants. We do believe that our current design significantly improves the quality of retail in the area and includes many of the critical attributes sought after in the General Plan.

RESPONSE TO STAFF COMMENTS:

- 1. Citizen Participation Plan A revised Citizen Participation Plan with a list of all land owners within 1,000 feet and all HOAs and registered neighborhoods within 1 mile has been resubmitted.
- 2. Notification Letters will be delivered to City of Mesa Development Services 2 weeks prior to our hearing.
- 3. Mesa 2040 General Plan -
 - We have 2 added sidewalks at the southwest corner of the property to better encourage pedestrian activity to our development. Enhanced hardscape features have also been added to the southeast corner to improve the aesthetics and be a

Thomas English Retail Real Estate, LLC City of Mesa – Follow-Up Submittal: ZON17-00597

Page 2 of 2

better complement to the adjacent corners of the intersection at Val Vista and Baseline. 1 additional sidewalk has also been added at the north property line to encourage pedestrian connectivity from the adjacent in-line strip center to the north of the site. It is also important to note, regarding Mesa 2040 General Plan, there are no residential dwellings adjacent or in close proximately to the subject property. The nearest residential area is more than 700' ft away and separated from our site by a large commercial development with multiple buildings.

- Another significant concern raised by Staff regarding our original layout were to two (2) dead-end drive aisles. We attempted to address Staff's concerns by adding multiple turn-around stalls, along with other minor site modifications to improve traffic circulation for the site. Staff suggested additional modifications could be made to better improve the layout. The current site plan eliminates the dead-end drive aisles and significantly improves the overall vehicular circulation of the site. The current site plan is also more open and therefore encourages pedestrian connective through and around our site by utilizing numerous connections points.
- 2 bicycle racks have been added in the front foundation setback area to encourage citizens using that mode of active transportation and bicycle enthusiast to view our site as a friendlier environment to visit and one that supports that that lifestyle.
- 4. Landscape Design We have significantly enhanced the landscape area at the southwest corner of the property, and also added hardscape features. This plan will greatly improve the sense of place and help serve as a gateway corner as you enter the city limits of Mesa. Installation and irrigation information will be provided in our Construction Documents.

CONCLUSION:

We believe that our revised site plan is a much stronger design and layout that will significantly improve vehicular circulation and reduce trip-time durations. Given that our site is not backed by any residential developments, the revised layout encourages pedestrian connectivity and adds multiple points of ingress and egress for pedestrian traffic. Bicycle connectivity has also improved with the added bike racks and multiple points of access. The current design will be a great compliment to the surrounding shops and serve as a quality retail destination for the citizens in the surrounding community into the future.

I appreciate your time in advance, and if you have any questions or need additional information, please contact me at (317) 574-7448 or email me at mrykovich@thomasenglish.com.


Sincerely,

Mark J. Rykovich, CCIM

Development Manager

EXHIBIT A

EXISTING DECLARATION - SITE PLAN

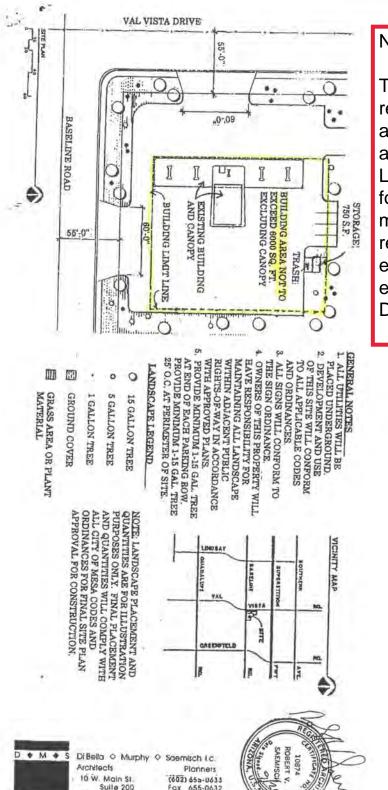



NOTE:

This is an exhibit of a recorded document. The area highlighted in yellow and labeled "BUILDING LIMIT LINE" is the limitations for where a future building may be developed/ redeveloped. See attached exhibit A_1 for all the parcels encompassed within this Declaration.

Revised EXHIBIT C

Mesa. AZ 85201

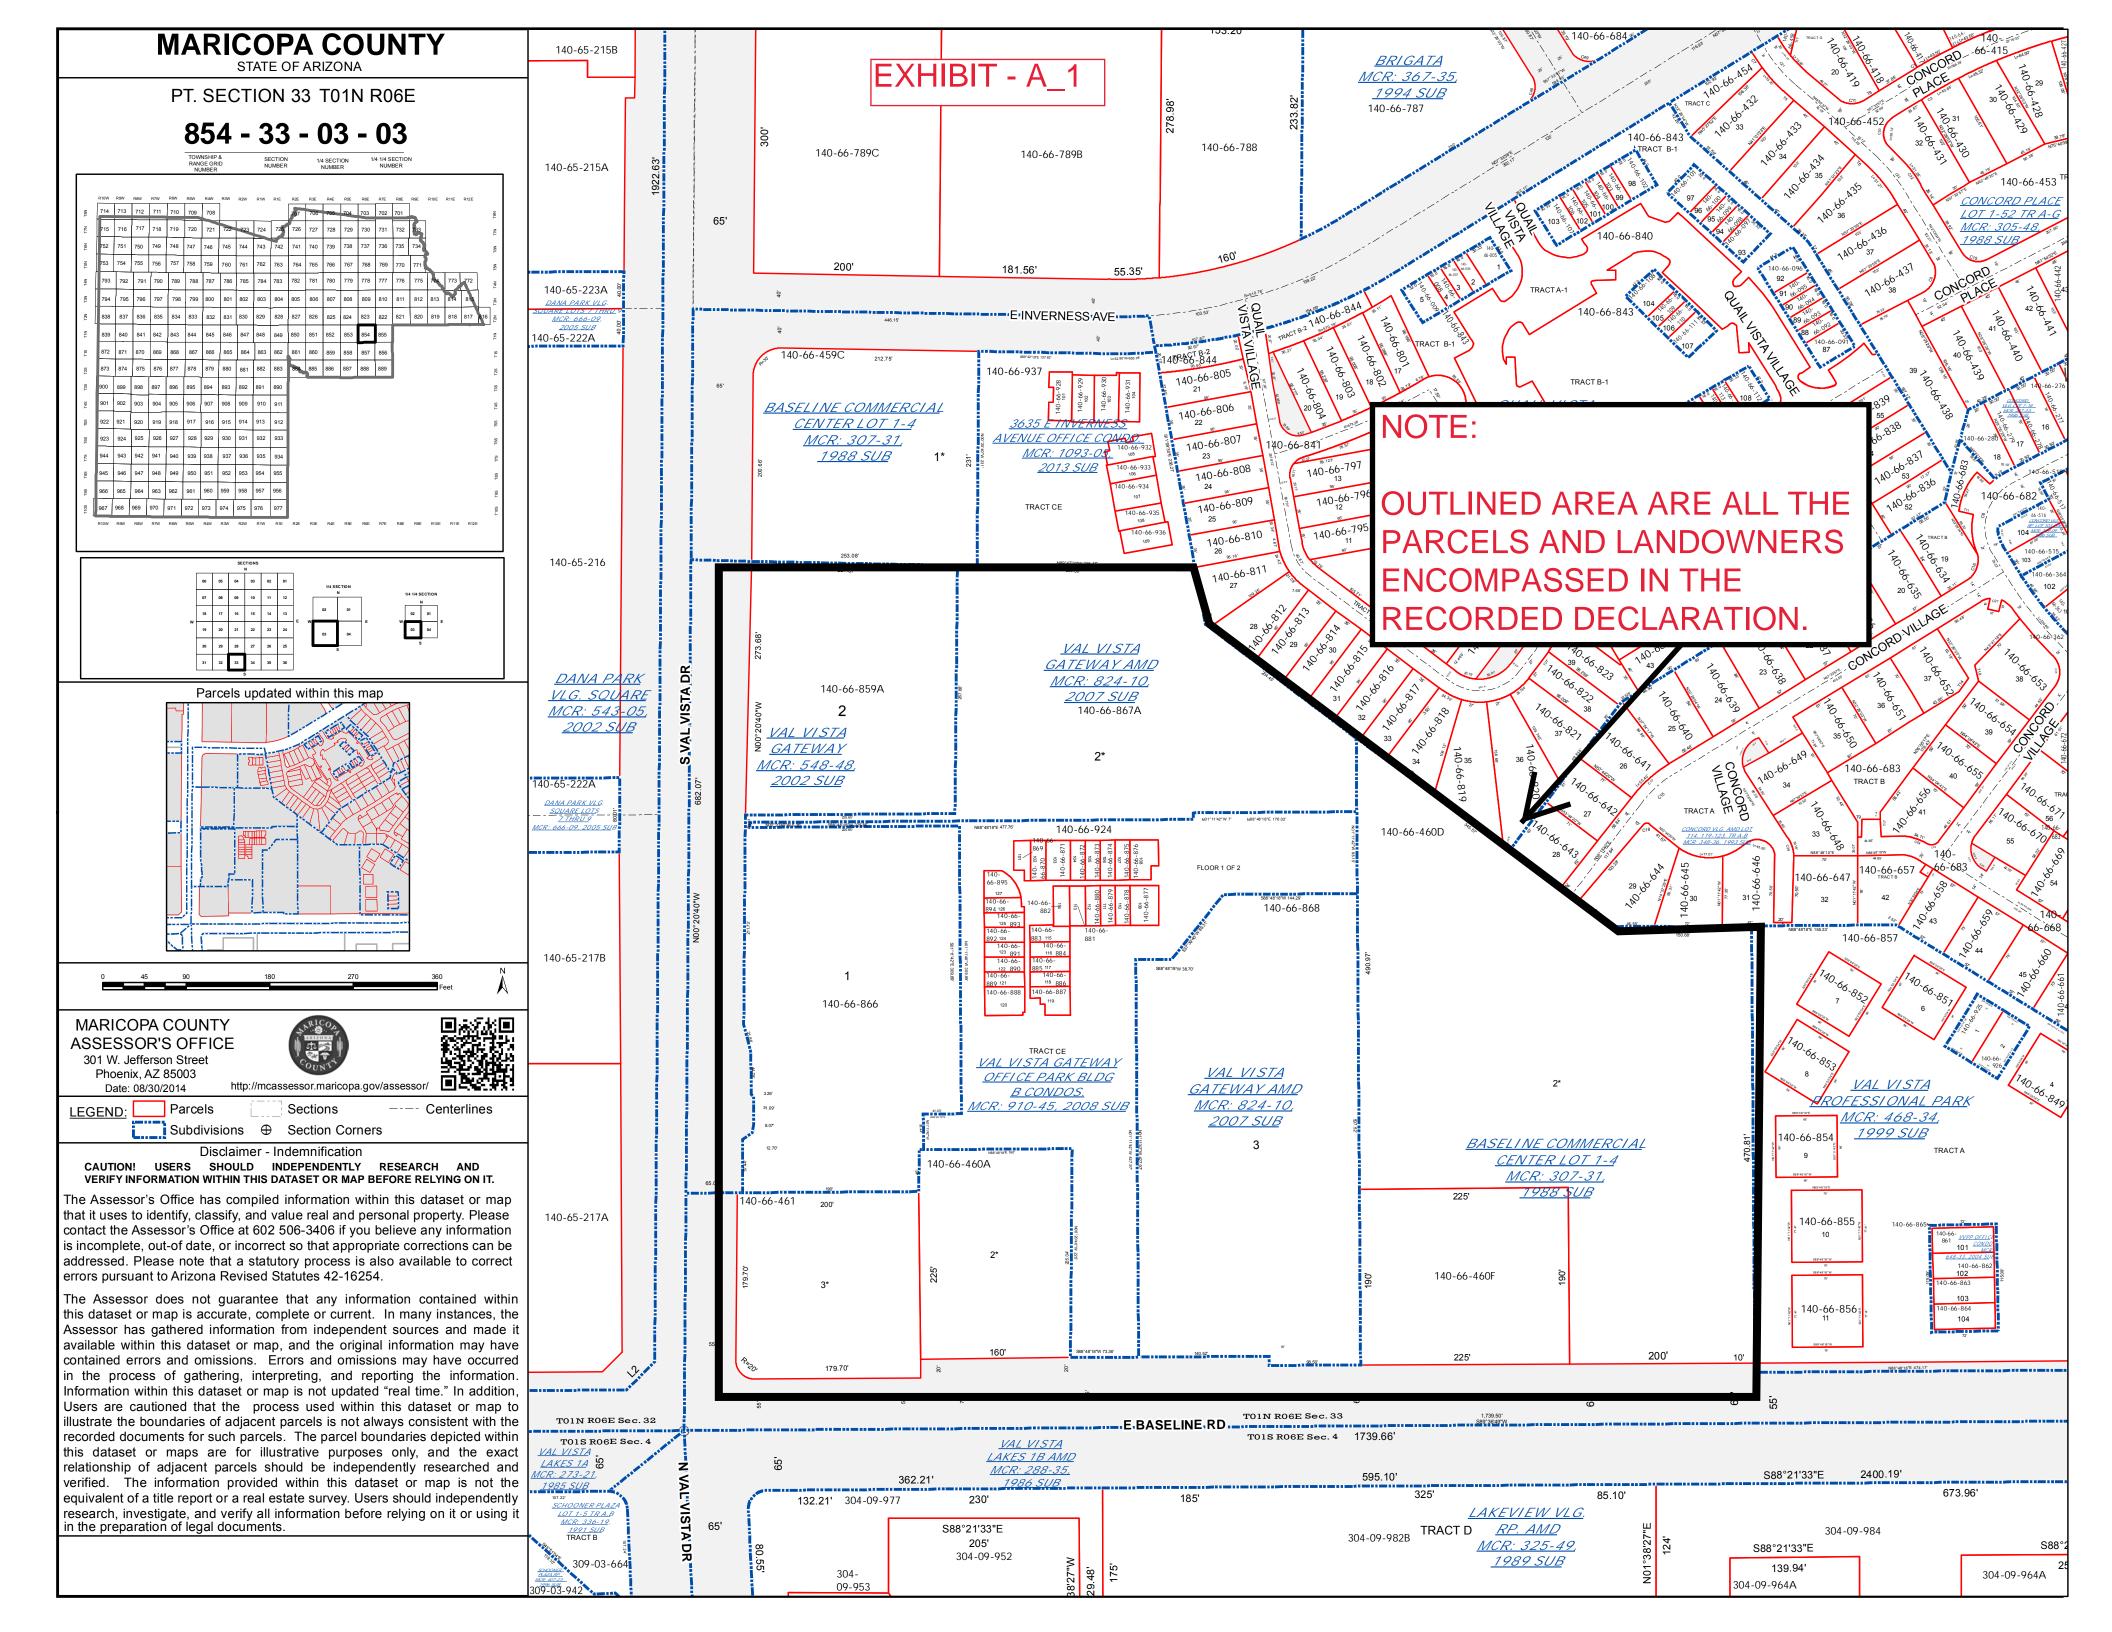

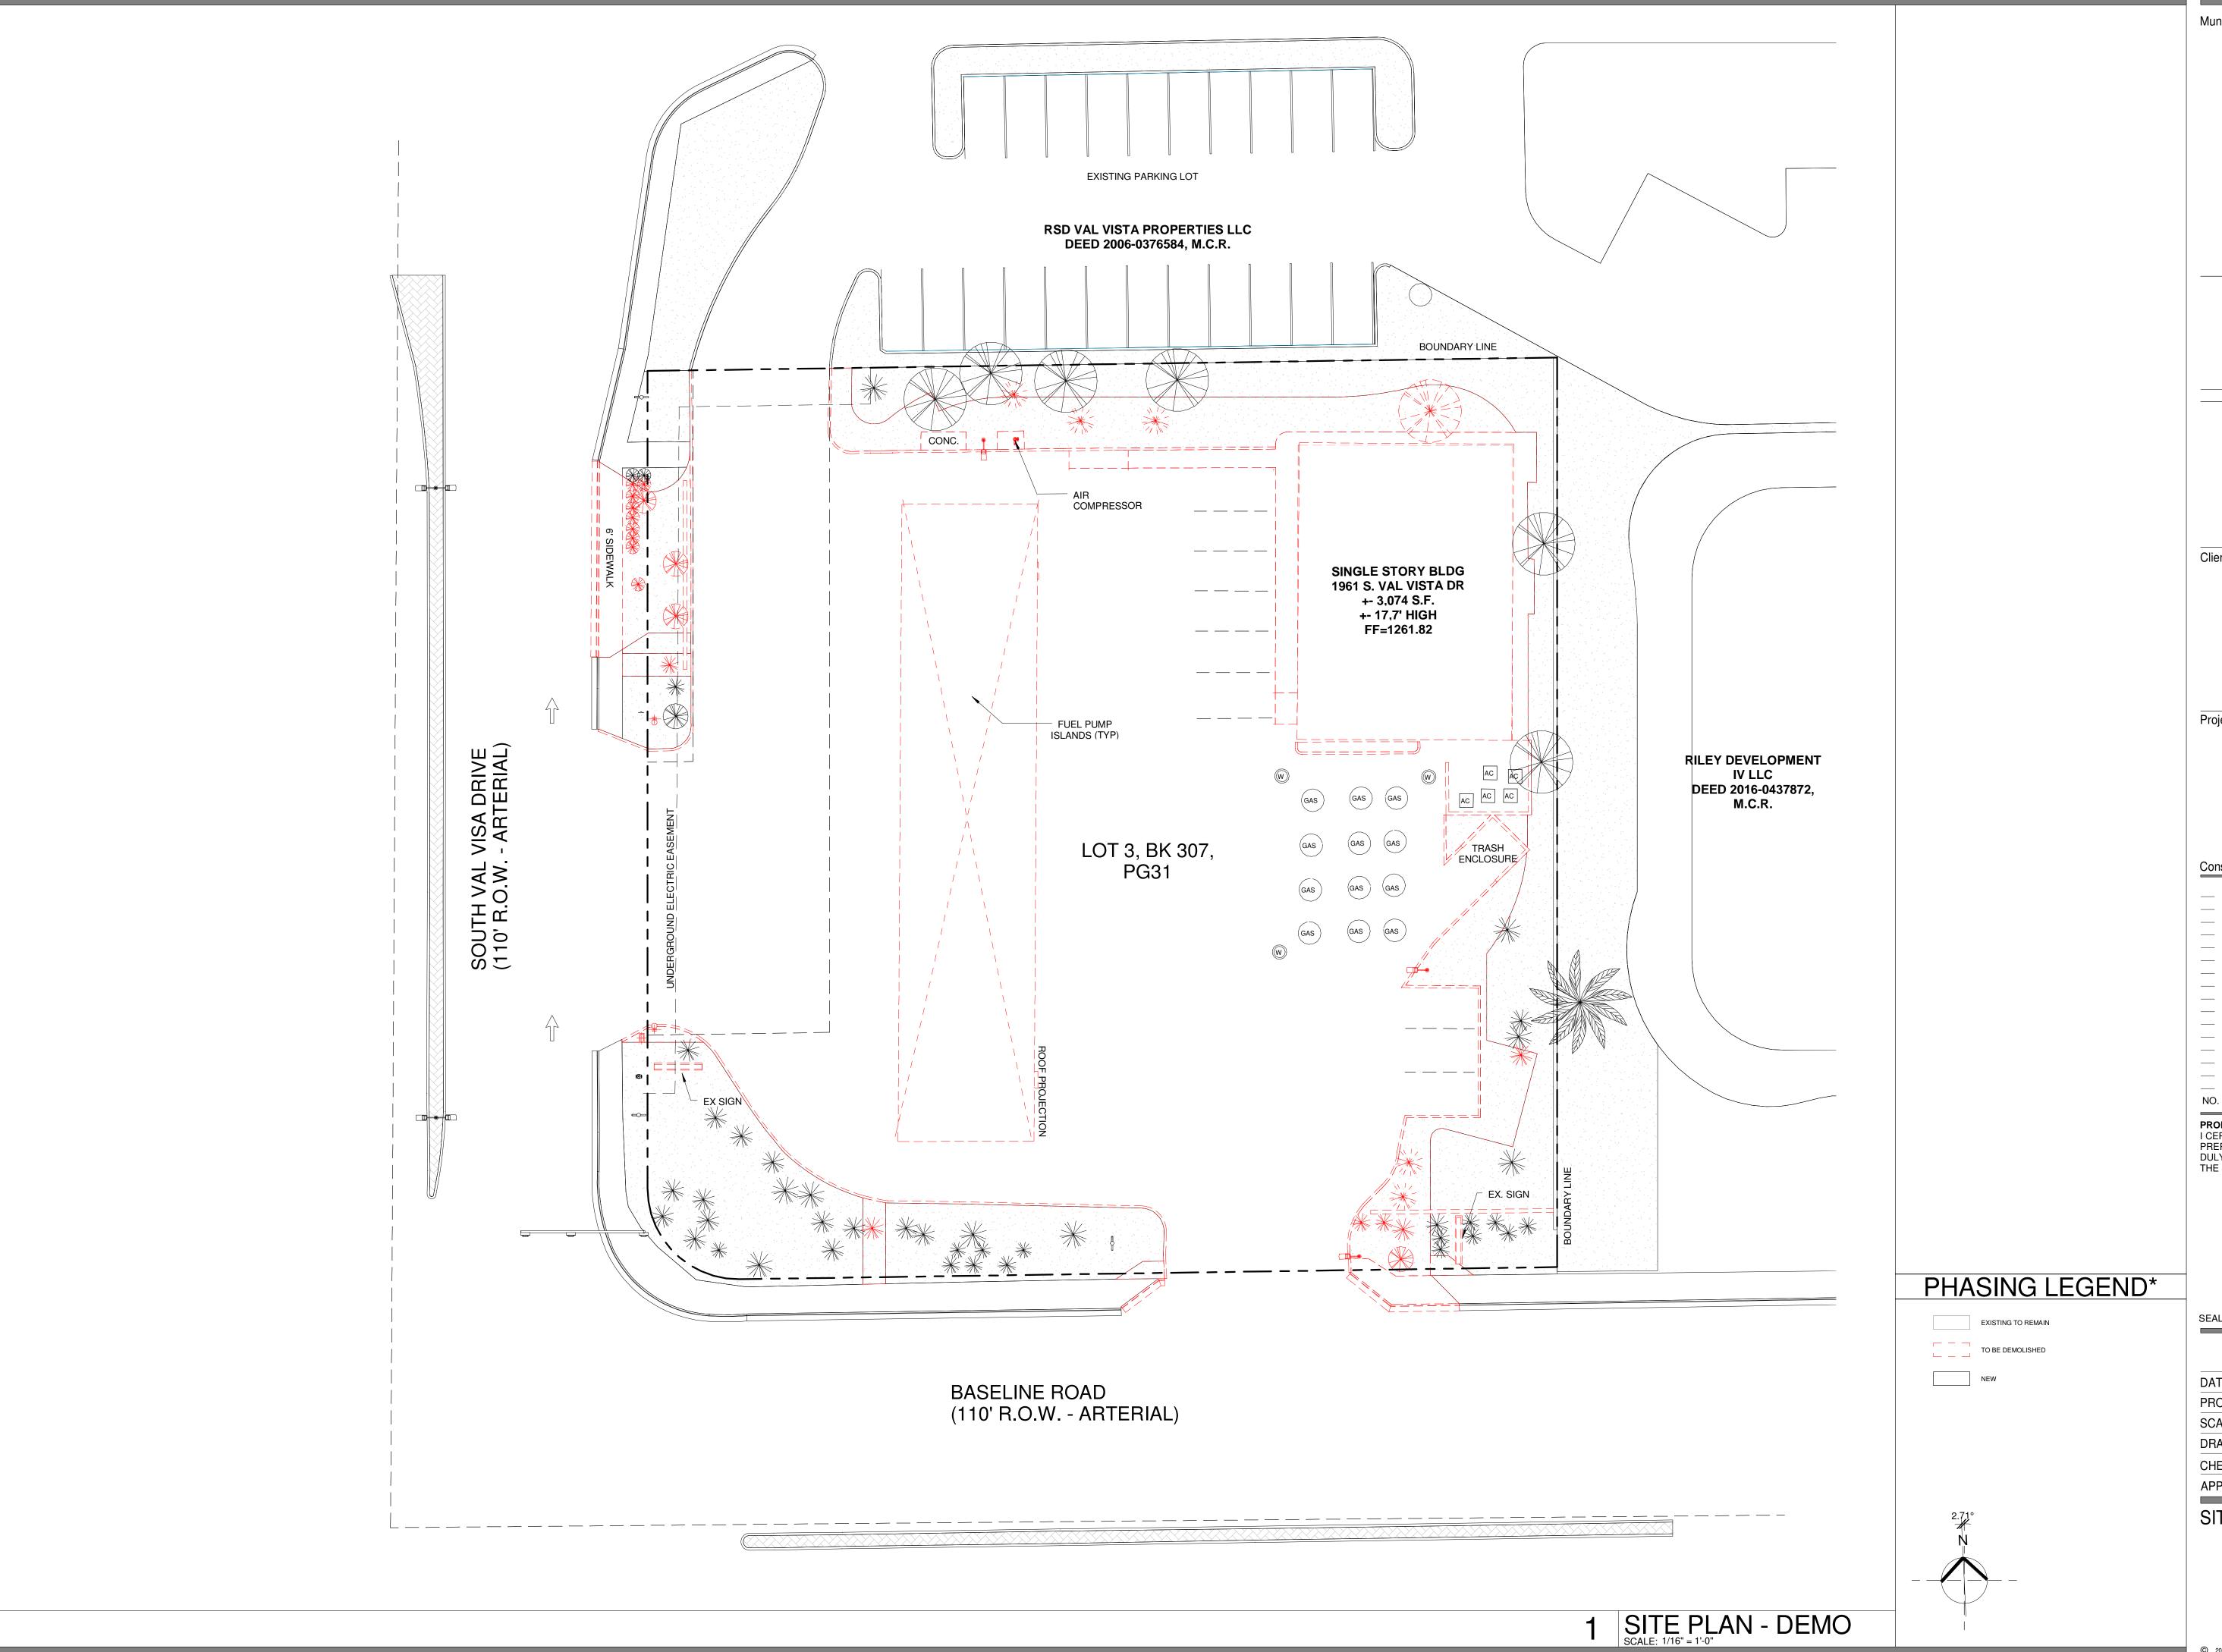



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Thomas English

Retail Real Estate THOMAS ENGLISH

725 E. 65TH STREET, STE 300 INDIANAPOLIS, IN 46220

Client

PROPOSED RETAIL DEVELOPMENT 1961 S. VAL VISTA DR MESA, AZ 85204

Project

Consultant 02/05/2018 ZONING/ DEIGN REVIEW INITIAL ISSUE

NO. DATE REVISIONS/ISSUANCES PROFESSIONAL CERTIFICATION:
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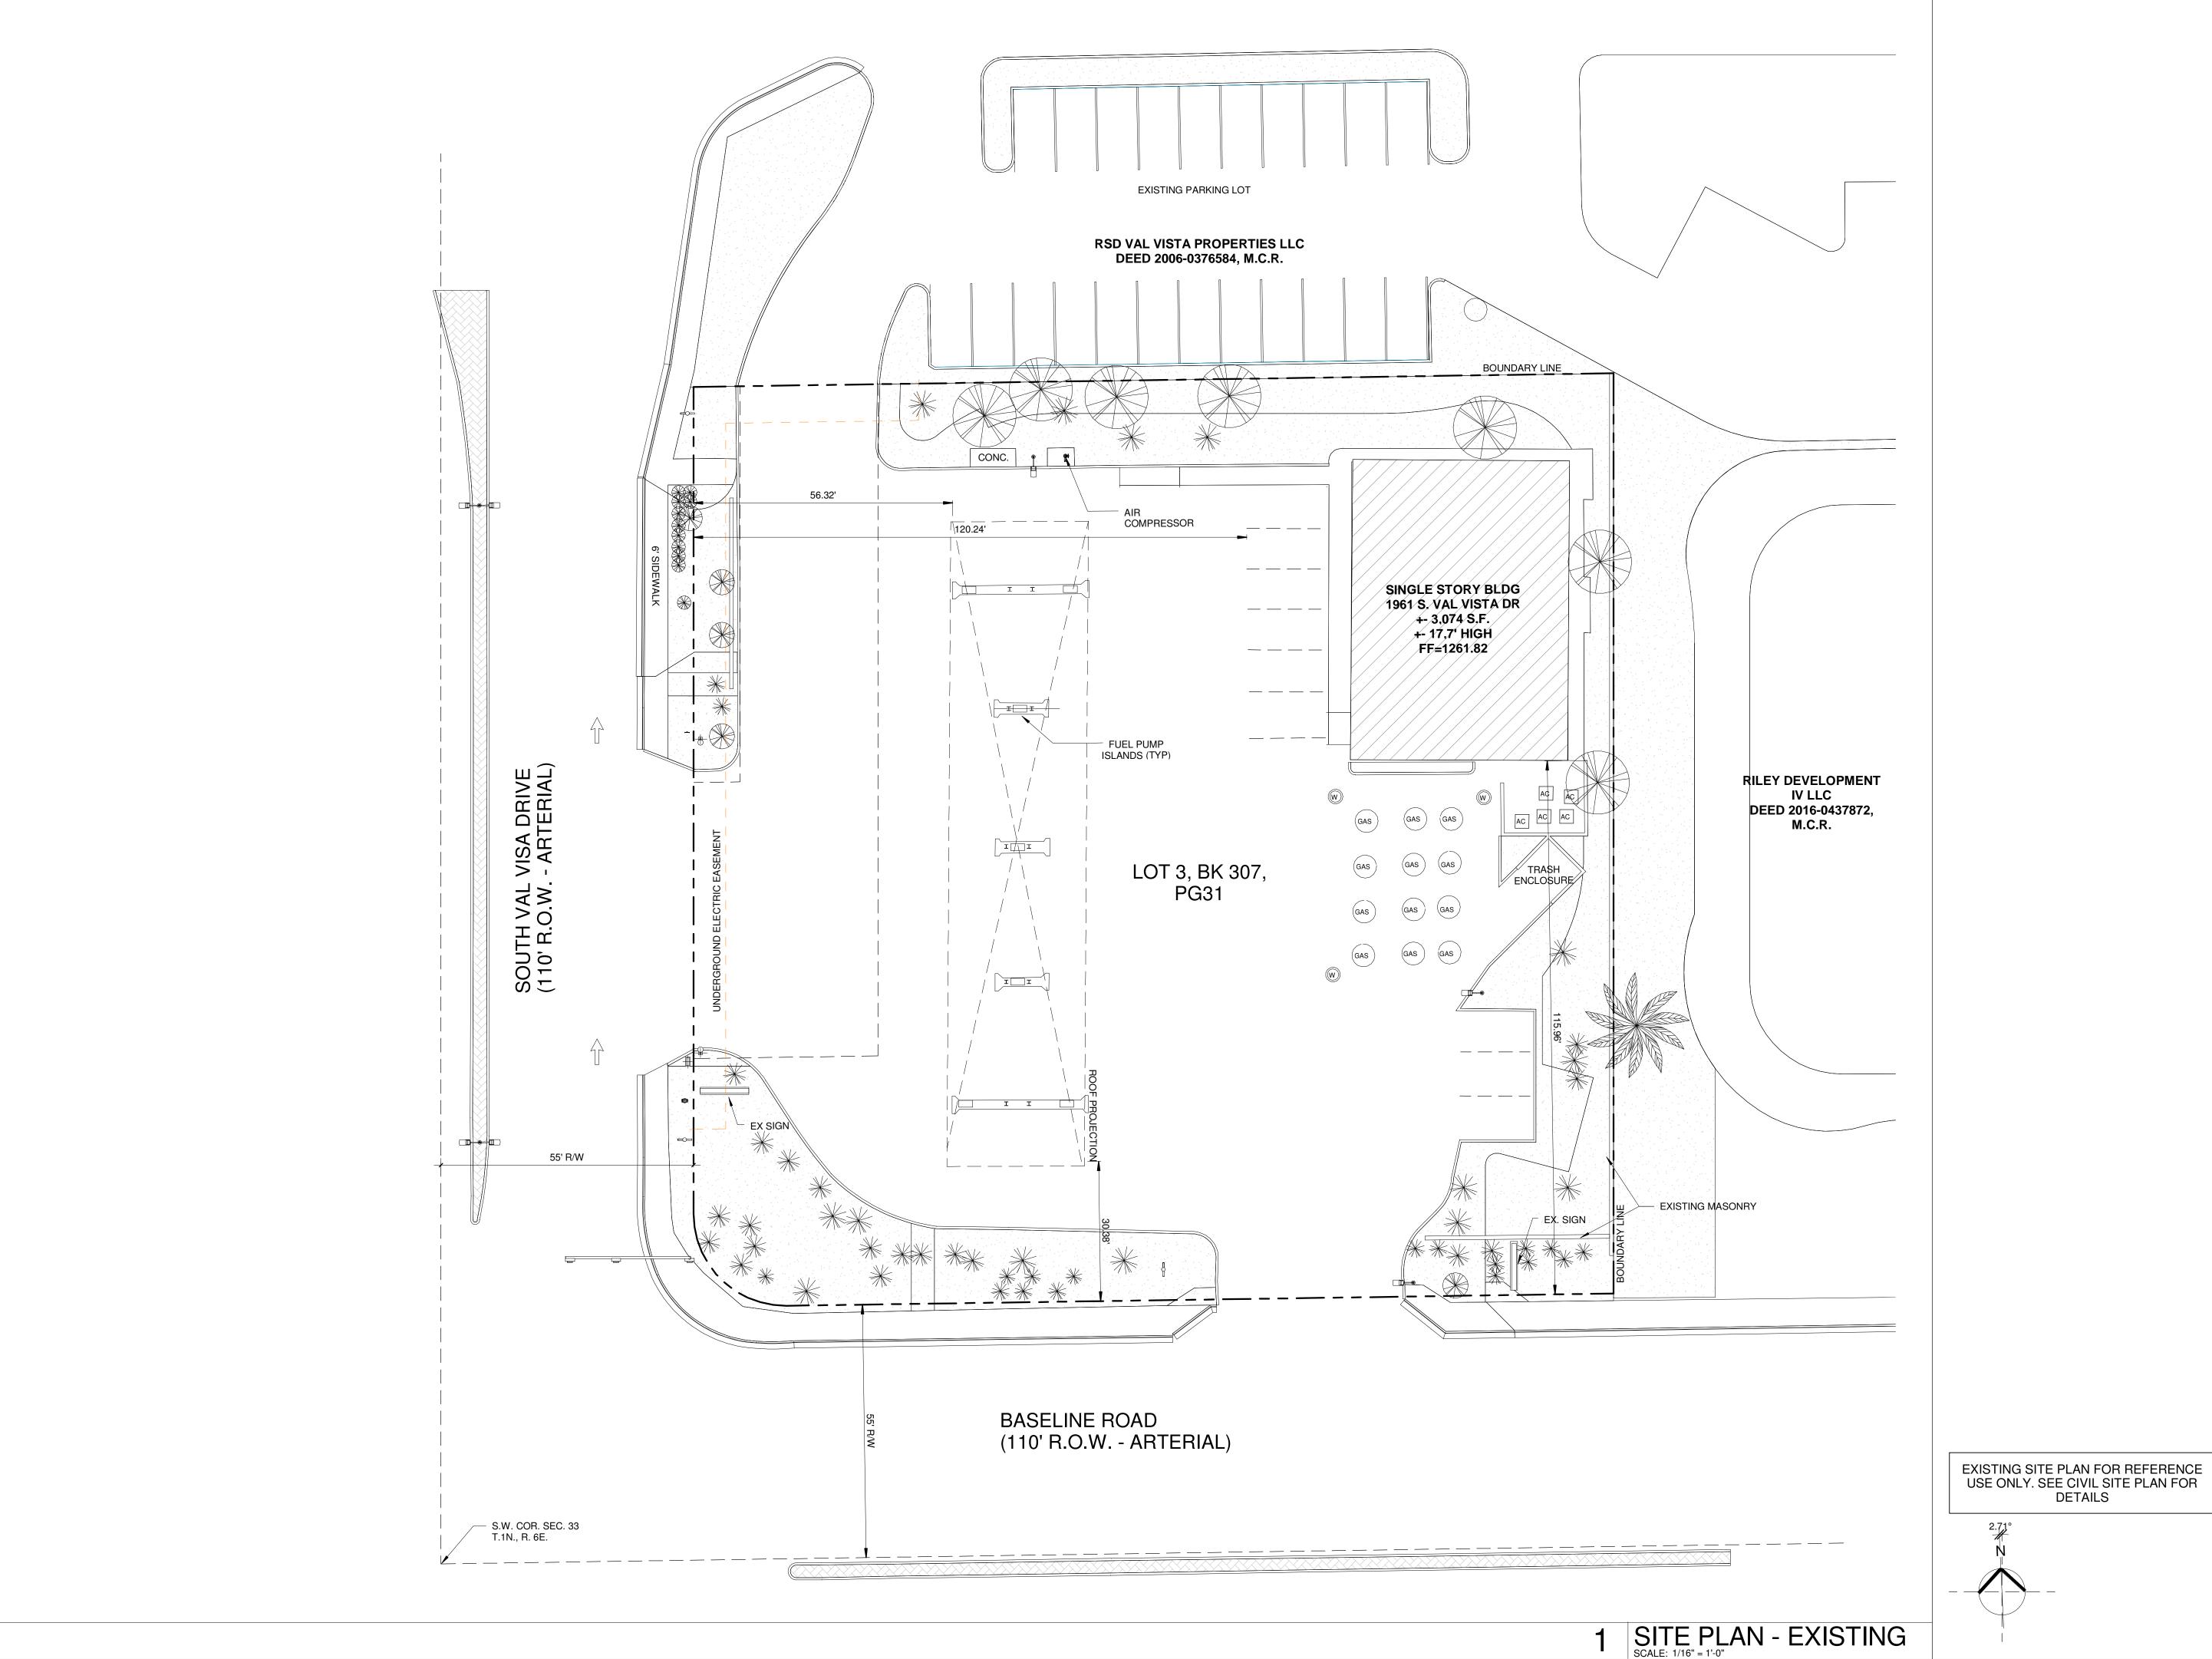


FOR PERMIT/ FOR BID

SITE PLAN - DEMO	
APPROVED BY:	ES
CHECKED BY:	BG
DRAWN BY:	DTE
SCALE:	As indicated
PROJECT NUMBER:	DXU#17-264
DATE:	02/05/2018

SITE PLAN - DEMO

A1-02





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Consultant

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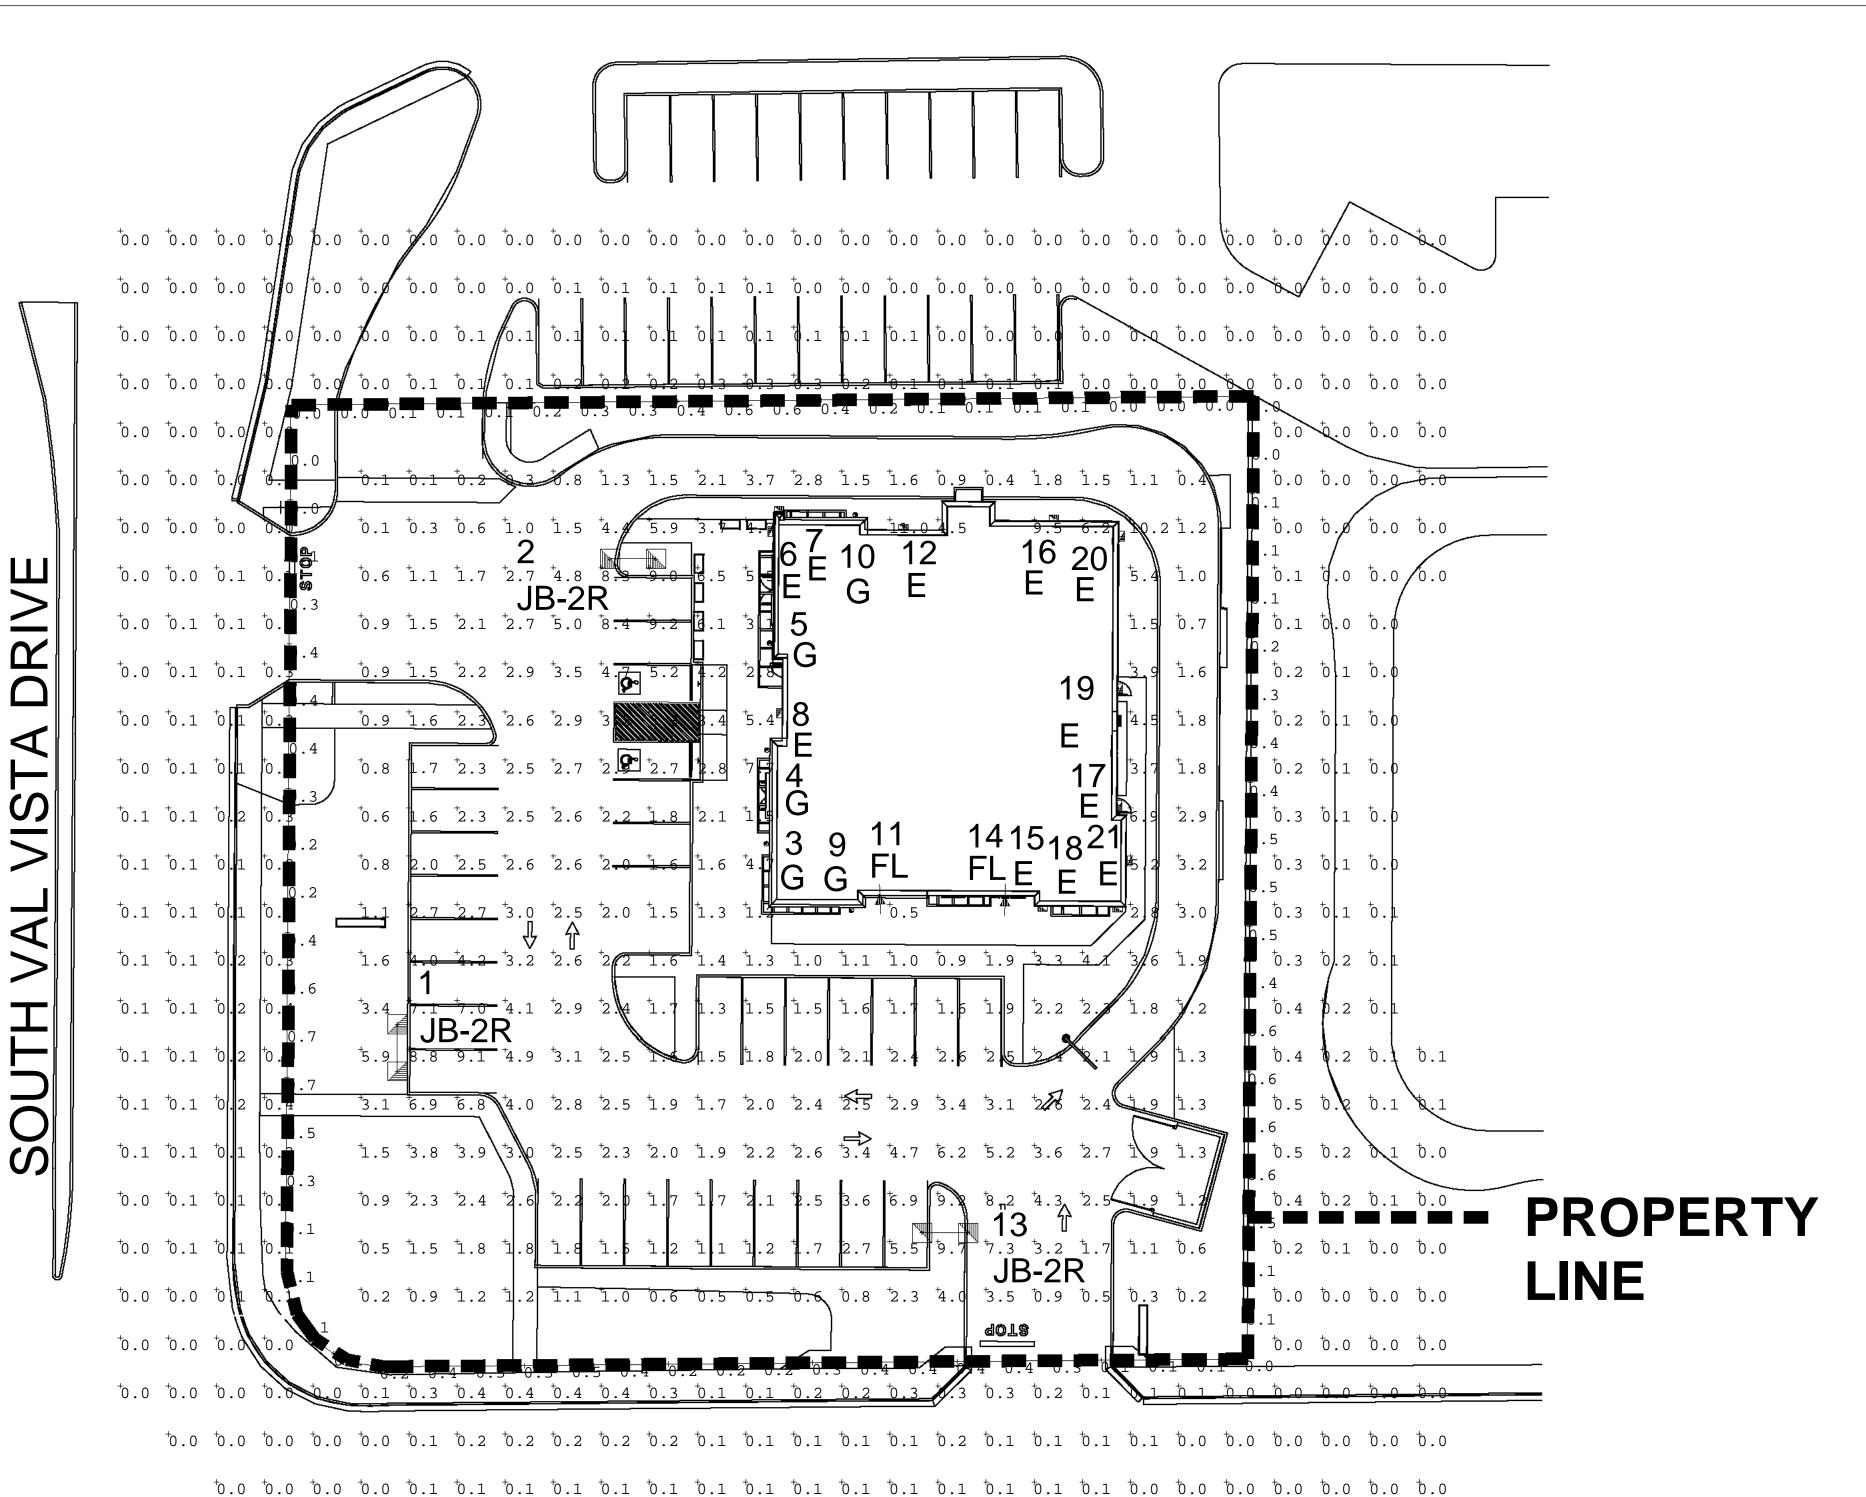


FOR PERMIT/ FOR BID

02/05/2018
DXU#17-264
1/16" = 1'-0'
DTE
BG
ES


SITE PLAN - EXISTING

A1-01




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EAST BASELINE ROAD

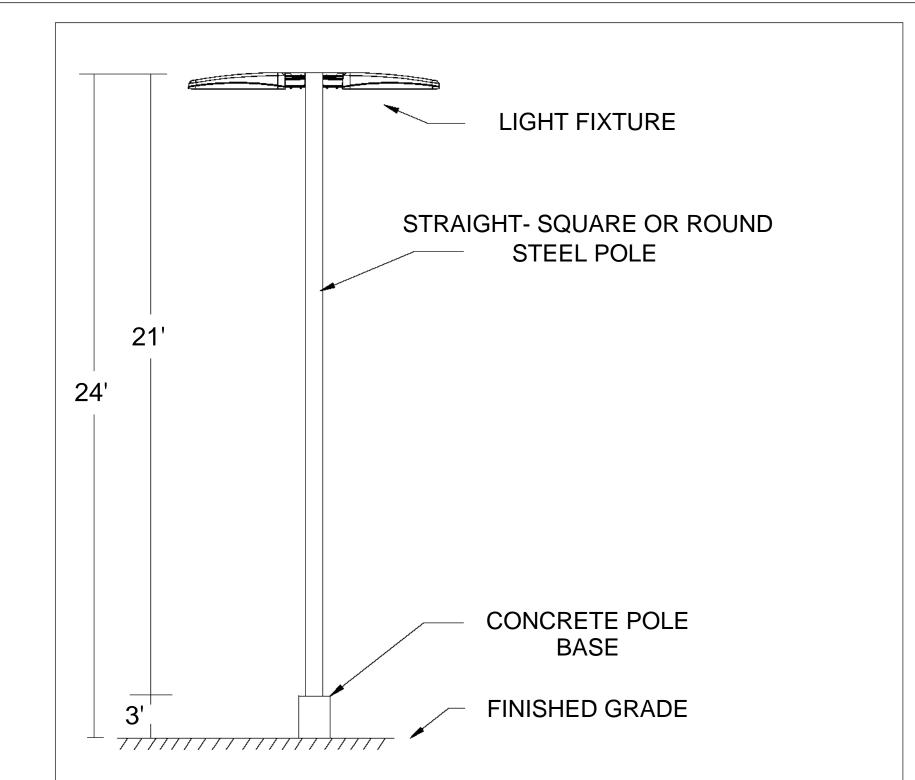

POLE DETAIL PARKING LOT

**THIS POLE FOOTING DETAIL IS TYPICAL, FOR INFORMATIONAL PURPOSES ONLY;
ACTUAL FOOTING SHOULD BE DESIGNED FOR THE SPECIFIC APPLICATION AND LOCATION
WITH CONSIDERATION TO ACTUAL REQUIRED SEISMIC, SOIL, WIND LOAD CONDITIONS, ETC.

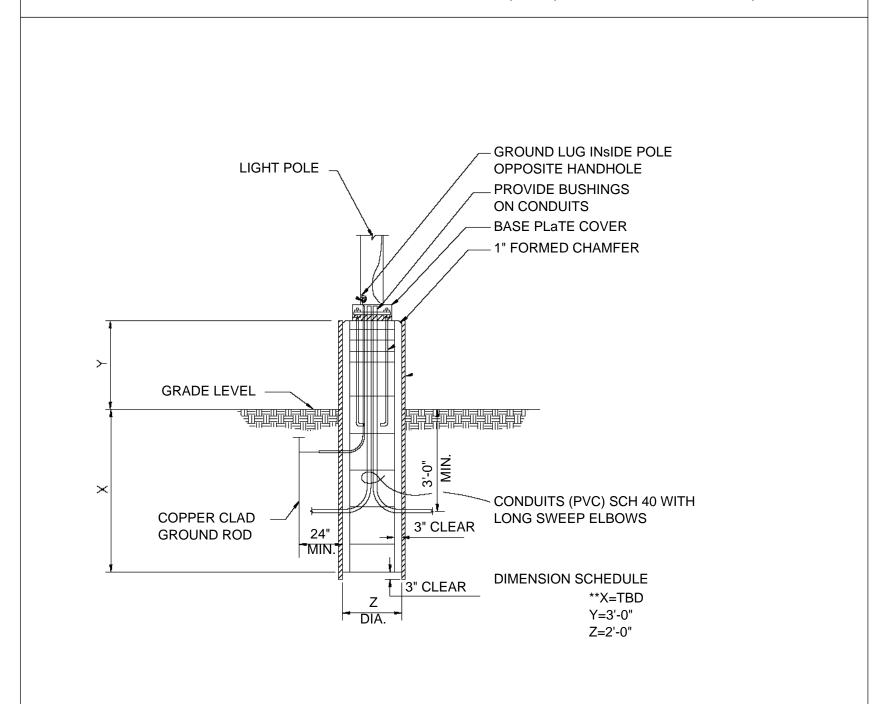

LIGHT POLE BASE DETAIL TYP.

1 LED PHOTOMETRIC PLAN SCALE: 1" = 20'

Calculation Summary						
Label	Avg	Max	Min	Avg/Min	Max/Min	# Pts
Property + 40 Ft	1.20	11.0	0.0	N.A.	N.A.	635
Property Line	0.28	0.7	0.0	N.A.	N.A.	79
Drive Entry & Exit - Top Left	2.03	8.2	0.1	20.30	82.00	28
Drive Thru & Back	3.39	11.0	0.4	8.48	27.50	53
Main Parking	2.87	9.2	0.5	5.74	18.40	126

Luminaire Sch	nedule	Э					
Symbol	Qty	Label	Arranged	TLL	LLF	Description	BUG Ratir
	11	E	SINGLE	N.A.	0.90	New Fixt 30W LED T2 8'-0 To 14'-0 Mtg Ht Wall Mt (4000K/X LED's/2820 Lumens/XXXmA) Sylvania Slim Wall Pack #74192 SLMWPK1A-030UNV740-CO-XX-X	B1-U0-G1
	2	FL	SINGLE	1858	0.90	New Wall Wash Flood 25W LED 5x5 FG 1'-0 Mtg Ht (4000K/12 LED's/2507 Lumens/700mA) Hubbell Beacon Flood FL-1_12NB-25-4K-5x5-UNV	N.A.
	5	G	SINGLE	N.A.	0.90	New Fixt 28W LED T5 VS 7'-0 Mtg Ht Up-Dn Wall Mt (3500K/X LED's/2600-2600 Lumens/110mA) Contech Lighting 6Dia Cyl X 16.25H Sconce CYL6435KMVDUDXNCLR-BZ	B2-U0-G0
	3	JB-2R	ROTATED OPTICS	N.A.	0.90	New Base, Pole & Fixt 105W LED T4 24'-0 Mtg Ht (4000K/48 LED's/12819 Lumens/700mA) Visionaire VSX-1-T4-48LC-7-4K-XXX	B2-U0-G3

BASED ON THE INFORMATION PROVIDED, ALL DIMENSIONS AND LUMINAIRE LOCATIONS SHOWN REPRESENT RECOMMENDED POSITIONS. THE ENGINEER AND/OR ARCHITECT MUST DETERMINE APPLICABILITY OF THE LAYOUT TO EXISTING OR FUTURE FIELD CONDITIONS.

THE LIGHTING PATTERN REPRESENTS ILLUMINATION LEVELS CALCULATED FROM LABORATORY DATA TAKEN UNDER THE CONTROLLED CONDITIONS UTILIZING CURRENT INDUSTRY STANDARD LAMP RATINGS IN ACCORDANCE WITH ILLUMINATING ENGINEERING SOCIETY APPROVED METHODS. ACTUAL PERFORMANCE OF ANY MANUFACTURER'S LUMINAIRE MAY VARY DUE TO VARIATION IN ELECTRICAL VOLTAGE, TOLERANCE IN LAMPS, AND OTHER VARIABLE FIELD CONDITIONS.

On-Site Lighting & Survey, LLC PH: 763.684.1548

PROJECT#	TE17 1	122	28-2
ISSUE DATE	12.28	.2017	7
DESIGN LEVEL	N	/A	
AGI	Z. NO	RDIN	ſ
CAD	J. MA	CKEY	<i>T</i>
SHEET#:	SL3.0	REV #:	3

On-Site Lighting & Survey, LLC

1111 HIGHWAY 25 NORTH SUITE 201 BUFFALO MN 55313

> PH:763.684.1548 FAX:763.682.9048

1961 VAL VISTA HABIT

1961 VAL VISTA DRIVE MESA. AZ 85204

THOMES ENGLISH

RETAIL REAL ESTATE

725 EAST 65TH STREET SUITE 300

INDIANAPOLIS, IN 46220

01.10.2018 JCM FIXTURE RESELECTION

LED

PHOTOMETRIC

PLAN

DESCRIPTION

SPECIFICATION SHEETS


NEW SITE PLAN


DATE

02.05.2018

01.02.2018 JCM



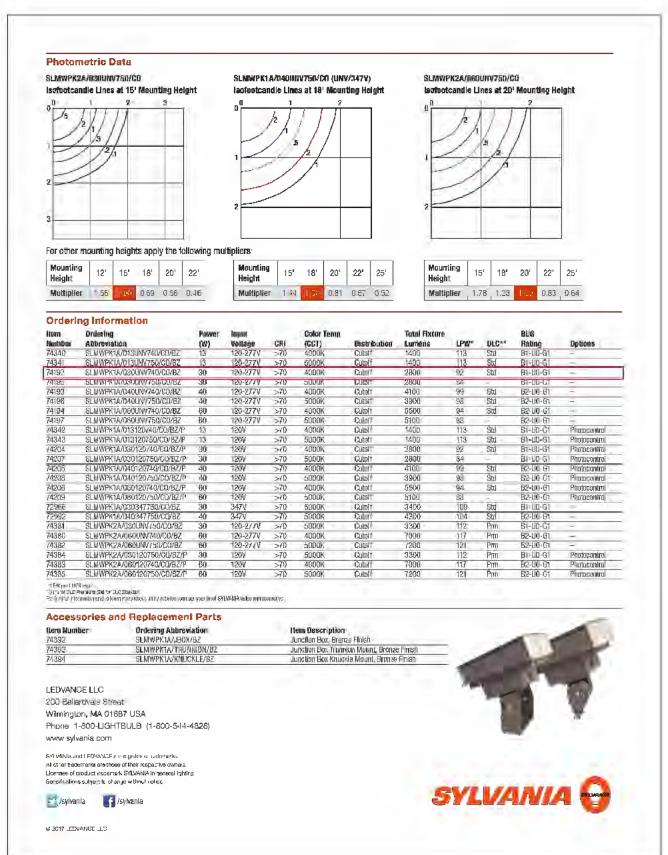

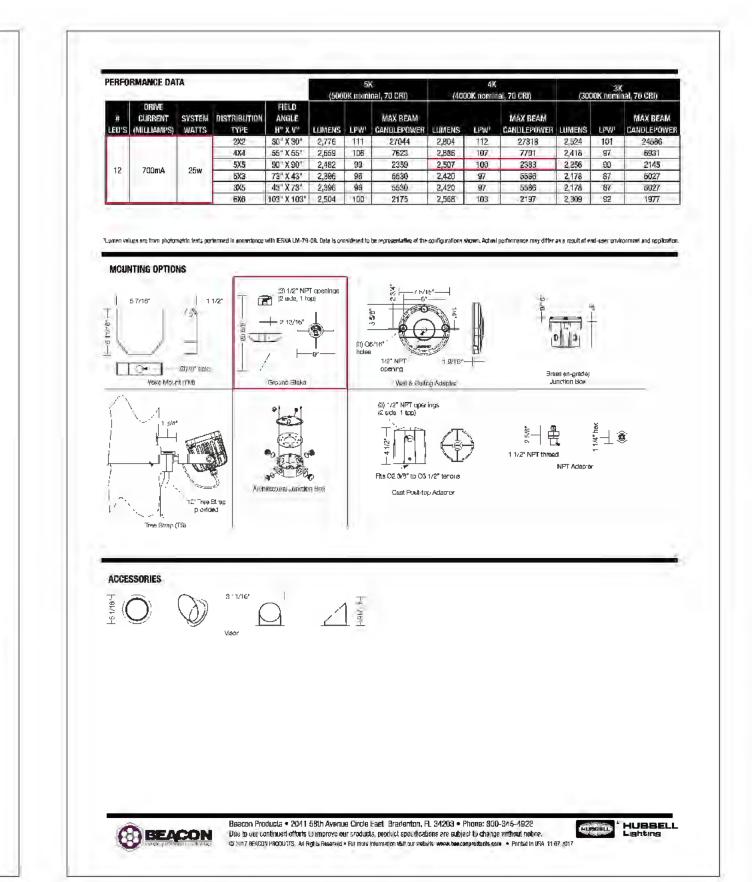


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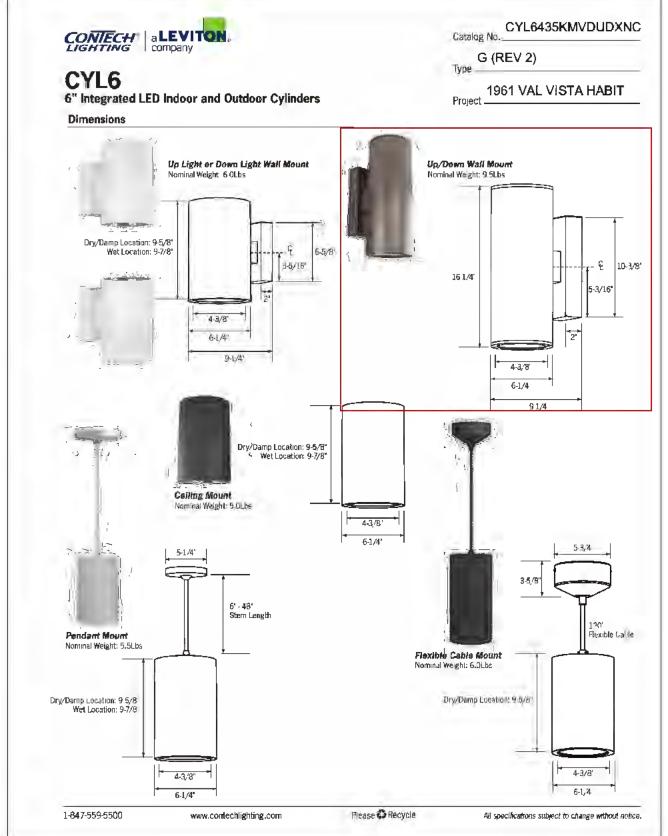
THE LIGHTING PATTERN REPRESENTS ILLUMINATION LEVELS CALCULATED FROM LABORATORY DATA TAKEN UNDER THE CONTROLLED CONDITIONS UTILIZING CURRENT INDUSTRY STANDARD LAMP RATINGS IN ACCORDANCE WITH ILLUMINATING ENGINEERING SOCIETY APPROVED METHODS. ACTUAL PERFORMANCE OF ANY MANUFACTURER'S LUMINAIRE MAY VARY DUE TO VARIATION IN ELECTRICAL VOLTAGE,

TOLERANCE IN LAMPS, AND OTHER VARIABLE FIELD CONDITIONS. FOR ADDITIONAL LIGHTING INFORMATION CONTACT: **On-Site Lighting**


& Survey, LLC PH: 763.684.1548





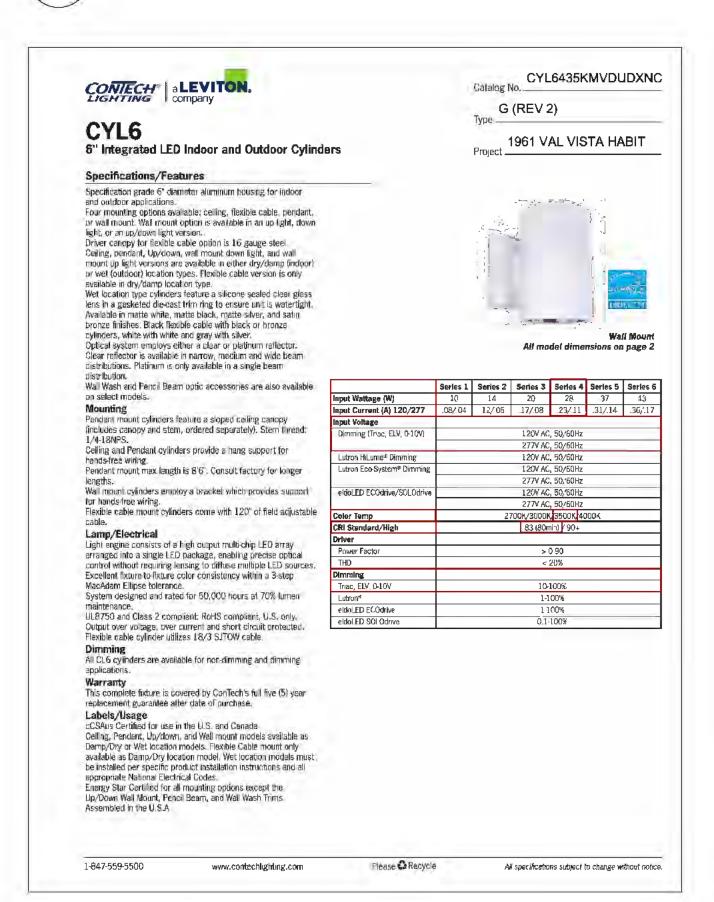

SURFACE MOUNT FIXTURE TYPE G **SPECIFICATION SHEETS**

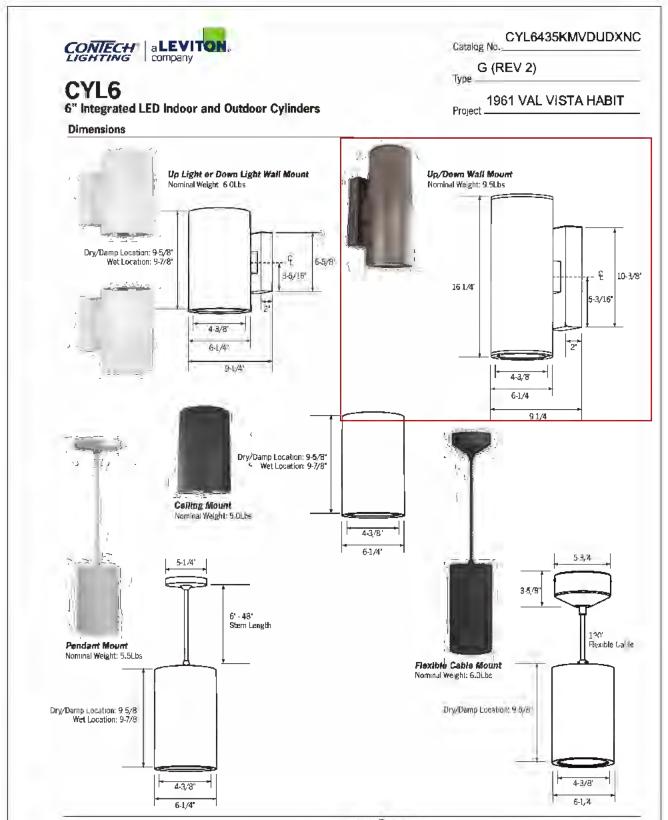

THOMES ENGLISH RETAIL REAL ESTATE 725 EAST 65TH STREET SUITE 300 INDIANAPOLIS. IN 46220 DATE INIT DESCRIPTION 01.02.2018 JCM SPECIFICATION SHEETS JCM FIXTURE RESELECTION 01.10.2018 02.05.2018 NEW SITE PLAN SURFACE MOUNT **FIXTURE SPECIFICATION SHEETS** TE171228-2 12.28.2017 N/A Z. NORDIN J. MACKEY

SL3.1

On-Site Lighting & Survey, LLC

1111 HIGHWAY 25 NORTH

SUITE 201

BUFFALO MN 55313

PH:763.684.1548

FAX:763.682.9048

1961 VAL VISTA

HABIT

1961 VAL VISTA DRIVE

MESA. AZ 85204

SPECIFICATION SHEETS

Cat# FL12L-254K75X5UNVGSDB

Fixture electrical compartment contains all LEC

*Dimming drivers are atandard, but must contact factory to request wiring leads for curpose of external dimming controls

 LiteshieldTM Circuit - protects lumineire trop exceesive temperature by interfacing with

the 0-10V dimmable drivers to reduce drive current as necessary

Finish: +IFS polyester powder-coat electrostatically applied and thermocured.

FS finish consists of a five stage pretreatme

regimen with a polymen primer sealer and rup coated with a thermoset super TGIC polyester

The finish mosts the AAMA 2604 performance

specification which includes passing a 3000 neur sall spray lest for corrosion resistance

and resists cracking or loss of adhesion per ASTM D522 and resists surface impacts of up to 160 inch-pounds.

CSA 22.2#250.13-14 for wet locations

1961 VAL VISTA HAI

driver components

Power factor is ≥.90 at full load

+Surge protection - 20kA

opwder coat finish.

Limitable shall include (as standard equipment)
a four position rotary dimining switch. The
switch shall be mounted on the PCB and used.

Limitags:

The Luminiaire shall bear a NRTL label and be

removing a sealing screw incredite like.

Following genoval of screw which may be notated with a small screwdriver. A metal insert.

The year imitted warranty. For more information, wait:

shall be provided in lens to accept the access www.hubb-#lighting.com/resources/warranty

ORDERING INFORMATION ORDERING EXAMPLE: FL/12L-25/3K7/3X5/UNV/YK/VS/DB

SK7 5000K, 70 CRI SX5 Medium fload

4K7

FL FL-1 121-25 25 Watts - 38/7 3000K, 70 CRI 2X2 Narrow spot LED Array 4000K, 70 CRI 4X4 Narrow flood

SERIES LED ENGINE CCT/CRI DISTRIBUTION VOLTAGE

5X5

5X3 Harizantal fland

Due to our scottinued affords to improve our products, product specifications are subject to change without notice.

2 2017 EEACW PRODUCTS, All follows because of Formers information discour violation was because of Formers information discourance of Formers information disco

SURFACE MOUNT FIXTURE TYPE FL

3X5 Vertical flood

UNV

Beacon Products • 2041 58th Avenue Circle East: Bradenton, FL 34203 • Phone: 800-345-4928

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GS

MOUNTING

YK Yake mount (std.)

TK Threaded ignuckle

PK Post top knuckle

AJ1 Architectural junction bins

WA1 Wall & celling adaptor

BX1 Brass junction box

GS' Ground stake

PA1 Cast post-top adaptor

TS¹ Tree strap 12NA² 1/2" NPT adaptor (std.)

to manually set dimming level to approximately marked suitable for wet locations. 25%, 50%, 75% and 100% or current. •CSA 22.2#250.13-14 for wet locations.

FL-1 (LED)

high powered flabdlight

HID lighting technology.

installation costs.

The FL-1 Floodlight is a high performance

 The housing and electrical comparament are mode from the cost atuninum that is pretreated and powder-coated to meet the most rugged industry standards.

LED energy and maintenence lighting solution, designed with optical versatility. Markets include: flags, columns, statuses, scourfly, halding floodlighting, lamblaspies. The FL-1 LED Hoodlight is intended to be used to reduce energy and maintenance associated with legacy.

Provides the best combination of vartical and

Features revolutionary individual LED optical commol baseo on high performance TIR optical

The previsely-designed optics result in fewer fixtures that use less energy, eading to lower life cycle costs along with lower up front

Dimming switch shall be accessible by

CERTIFICATIONS/LISTINGS

FL 12L-25

SPECIFICATIONS

Intended Use:

Construction:

BEACON Beign Aufenname Techniche

-- 5 9" 6" --

6 6/46" —

H 6 1/47 ---

DB

DB Dark bronze textured

WH White textured


PS Plat, silver smooth

EYB Light gray smooth

GT Graphite textured


CC Custom color


PRODUCT IMAGE(S)

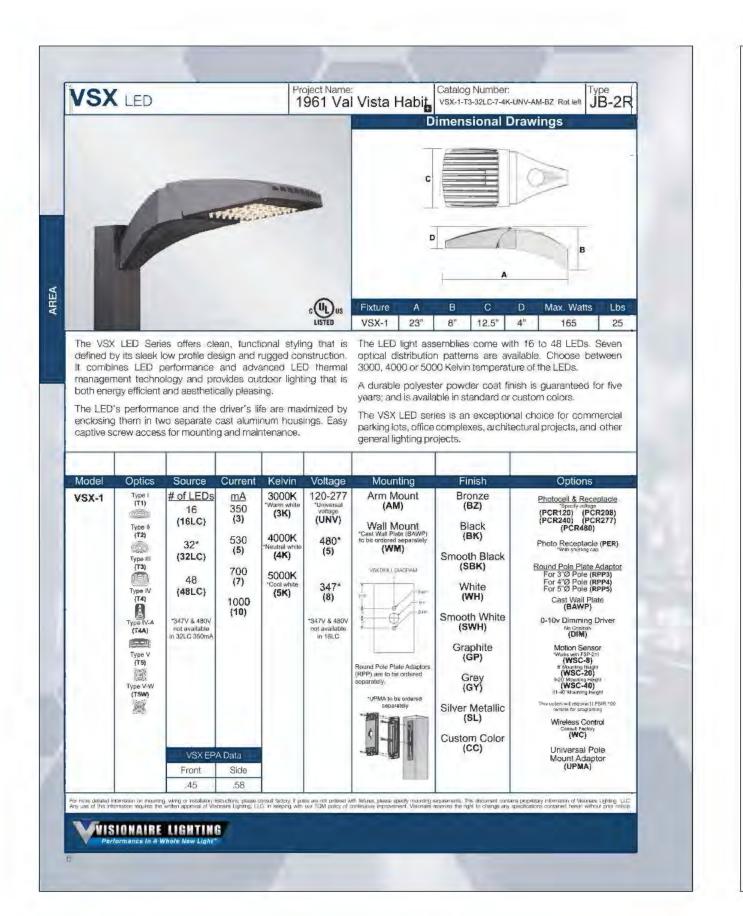

									JB-2R
	caled Lumen Charts				1961 V	AL VIS	TA HA	BII - M	ESA, AZ
# of LEDS	Current(mA)	T1	T2	T3	T4	T4A	T5	T5W	Wattage
1	350	2398	2205	2224	2176	2406	2344	2216	18
16	530	3216	2959	2983	2919	3228	3144	2974	26
'° [700	4629	4259	4293	4201	4646	4525	4279	36
	1050	6010	5529	5573	5455	6032	5875	5556	55
	350	4786	4403	4439	4344	4804	4679	4424	37
32	530	6422	5908	5956	5829	6445	6278	5937	57
¥ _	700	Z980	7323	7382	7224	7988	7781	7358	70
	1050	12520	11518	11611	11364	12565	12239	11574	107
	350	6568	6043	6091	5962	6592	6421	6072	55
48	530	8812	8107	8172	7998	8844	8615	8146	82
40	700	13330	12265	12364	12100	13379	13031	12324	105
	1050	18254	16793	16929	16568	18321	17845	16876	160
000K		0.7				1			
# of LEDS	Current(mA)	T1	T2	T3	T4	T4A	T5	T5W	Wattage
	350	2540	2336	2356	2305	2549	2483	2348	18
16	530	3407	3135	3161	3093	3420	3331	3151	26
10	700	4904	4512	4548	4451	4923	4794	4533	36
	1050	6367	5857	5905	5779	6391	6224	5886	55
	350	5071	4665	4703	4602	5089	4957	4687	37
32	530	6804	6259	6310	6176	6829	6651	6290	57
J2_	700	8433	7759	7820	7654	8463	8244	7796	70
	1050	13264	12203	12301	12039	13312	12966	12262	107
L	350	6959	6402	6453	6316	6984	6803	6433	55
48	530	9335	8589	8658	8473	9370	9127	8631	82
-~ L	700	14123	12994	13099	12819	14175	13806	13057	105
	1050	19339	17792	17936	17553	19410	18906	17879	160
000K									
# of LEDS	Current(mA)	T1	T2	T3	T4	T4A	T5	T5W	Wattage
	350	2592	2384	2404	2352	2601	2534	2396	18
16	530	3477	3199		3156		3399	3215	
· · · L	700	5004	4604		4542	5023	4892	4626	
	1050	6497	5977	6025	5897	6521	6351	6006	55
<u> </u>	350	5174	4760	4799	4696	5193	5058	4783	37
32	530	6943	6387	6439	6302	6968	6787	6418	57
<u> </u>	700	8605	7917	7980.	7810	8636	8412	7955	70
	1050	13535	12452	12552	12285	13584	13231	12512	107
L	350	7101	6533	6585	6445	7127	6942	6564	55
48	530	9526	8764	8835	8646	9561	9318	8807	82
	700	14411	13259	13366	13081	14464	14088	13323	105
	1050	19734	18155	18302	17911	19806	19292	18244	160

POLE MOUNT FIXTURE TYPE JB-2R ROTATE LEFT **SPECIFICATION SHEETS**

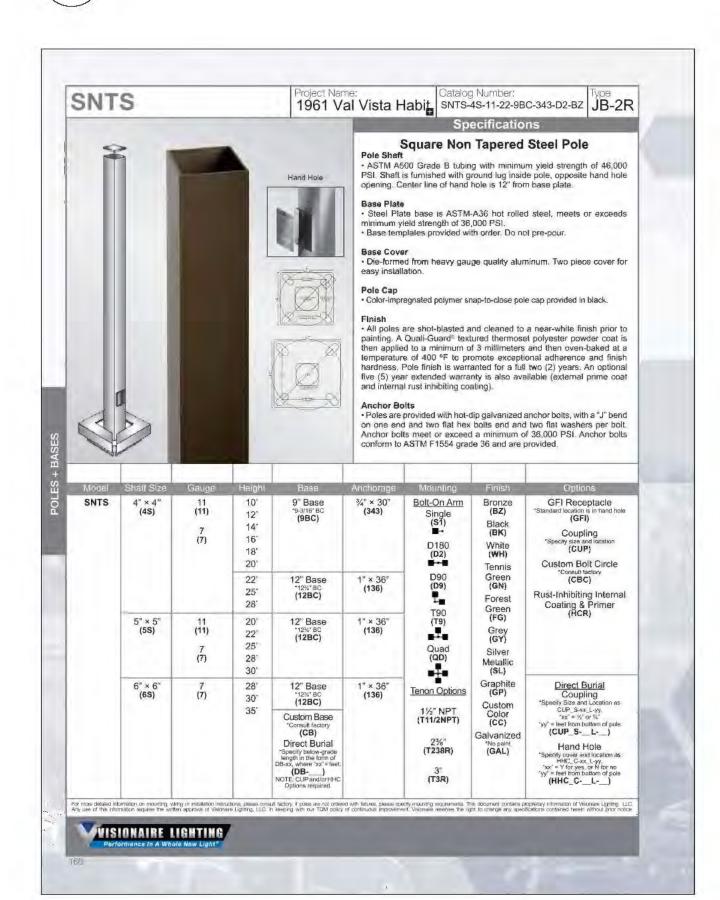


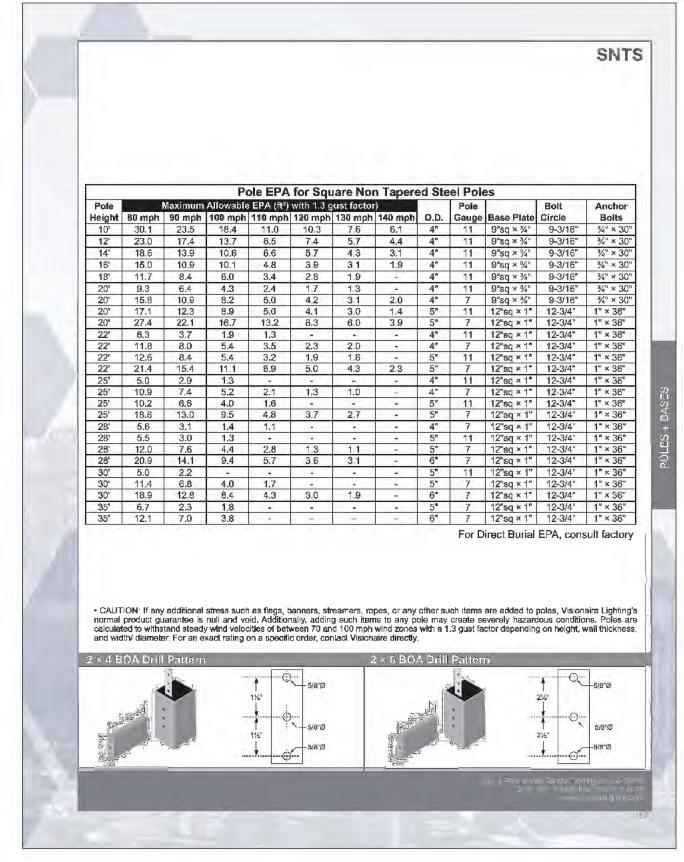

POLE TYPE JB-2R SPECIFICATION SHEETS

JON	LED			1 1	oject Name 961 Va	l Vista Habi	Catalog Number: vsx-1-т3-32LC-7-4k-L Dimensional D	00 211
defined by It combir manager both ener	y its sleek nes LED nent techn gy efficient	ies offers cle low profile de performance ology and pri and aesthetic ance and the	sign and and adv ovides ou cally pleas	rugged co anced LE itdoor light ing.	ng that is natruction. D thermal ling that is	optical distribution 3000, 4000 or 50 A durable polyes years; and is avail	B C 8" 12.5" semblies come within patterns are avious Kelvin temperature repowder coat finable in standard or	nish is guaranteed for five custom colors.
enclosing	them in the	wo separate os for mountin	cast alum	num haus			complexes, archite	nal choice for commercial ectural projects, and other
Model VSX-1	Optics Type I	Source # of LEDs	Current mA	Kelvin 3000K	Voltage 120-277	Mounting Arm Mount	Finish Bronze	Options Photocell & Receptacle
,	(T1) Type II	16 (16LC)	350 (3)	*Warm white (3K)	*Universal voltage (UNV)	(AM) Wall Mount	(BZ) Black	"Specify voltage (PCR120) (PCR208) (PCR240) (PCR277) (PCR480)
	(T2) Type III	32* (32LC)	530 (5)	4000K *Neutral white (4K)	480° (5)	*Cast Wall Plate (BAWP) to be ordered separately (WM)	(BK) Smooth Black	Photo Receptacle (PER)
	(ET)	48	700 (7)	5000K	347*	VSX DRILL DIACSRAM	(SBK) White	Round Pole Plate Adaptor For 3"Ø Pole (RPP3) For 4"Ø Pole (RPP4) For 5"Ø Pole (RPP5)
	Type IV (T4)	(48LC)	1000	(5K)	(8)	07 07	(WH)	Cast Wall Plate (BAWP)
1	Type (V-A (T4A)	1347V & 480V not available in 32LC 350mA			not available in 16LC	1 9	Smooth White (SWH)	0-10v Dimming Driver No Coulobs (DFM)
	Type V					Round Pole Plate Adaptors (RPP) are to be ordered	Towns of the last	Motion Sensor Works with 159-211 (WSC-8) 8 Mounting regin (WSC-20)
	(175)					separately.	Grey (GY)	9-20: Mounting Height (WSC-40) 21-40: Mounting Height
						benefits at AMPU.	College & College College	This pulpy will recrise 11 PSIR 100
	(T5) Type V-W					separately	Silver Metallic (SL)	This collect will require full PSIR #00 remails for programing Wireless Control Sonaut Factory
	(T5) Type V-W	VSX EPA	A Data					Wireless Control Consult Festory (WC) Universal Pole Mount Adaptor
	(T5) Type V-W	VSX EP/ Front .45	A Data Side .58				(SL) Custom Color	Wireless Control Consul Factor (WC) Universal Pole

3000K	Scaled Lumen Charts				1961 \	AL VIS	TA HA	BIT - M	JB-2R ESA, AZ
# of LEDS	Current(mA)	T1	T2	ТЗ	T4	T4A	⊺5	T5W	Wattage
" OF LEGG	350	2398	2205	2224	2176	2406	2344	2216	18
	530	3216	2959	2983	2919	3228	3144	2974	26
16	700	4629	4259	4293	4201	4646	4525	4279	36
	1050	6010	5529	5573	5455	6032	5875	5556	55
	350	4786	4403	4439	4344	4804	4679	4424	37
	530	6422	5908	5956	5829	6445	6278	5937	57
32	700	7960	7323	7382	7224	7988	7781	7358	70
ľ	1050	12520	11518		11364		12239	11574	107
	350	6568	6043	6091	5962	6592	6421	6072	55
	530	8812	8107	8172	7998	8844	8615	8146	82
48	700	13330	12265	12364	12100	13379	13031	12324	105
	1050	18254	16793	16929	16568	18321	17845	16876	160
1000K									
# of LED\$	Current(mA)	T1	⊤2	Т3	T4	T4A	T5	T5W	Wattage
	350	2540	2336	2356	2305	2549	2483	2348	18
16	530	3407	3135	3161	3093	3420	3331	3151	26
	700	4904	4512	4548	4451	4923	4794	4533	36
	1050	6367	5857	5905	5779	6391	6224	5886	55
20	350	5071	4665	4703	4602	5089	4957	4687	37
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40	700	14123	12994	13099	12819	14175	13806	13057	105
	1050	19339	17792	17936	17553	19410	18906	17879	160
000K									1.0
# of LEDS	Current(mA)	T1	T2	T3	T4	T4A	T5	T5W	Wattage
	350	2592	2384	2404	2352	2601	2534	2396	18
16	530	3477	3199	3225	3156	3490	3399	3215	26
'` [700	5004	4604	4641	4542	5023	4892	4626	36
	1050	6497	5977	6025	5897	6521	6351	6006	
L	350	5174	4760	4799	4696	5193	5058	4783	
32	530	6943	6387	6439	6302	6968	6787	6418	
~~ I	700	8605	7917	7980			8412	7955	70
	1050	13535		12552	12285	100	13231	12512	107
ļ	350	7101	6533	6585	6445	7127	6942	6564	55
48	530	9526	8764	8835	8646		9313	8807	82
	700	14411				14464	14088	13323	105
The state of the s	1050	19734	18155	18302	17911	19806	19292	18244	160

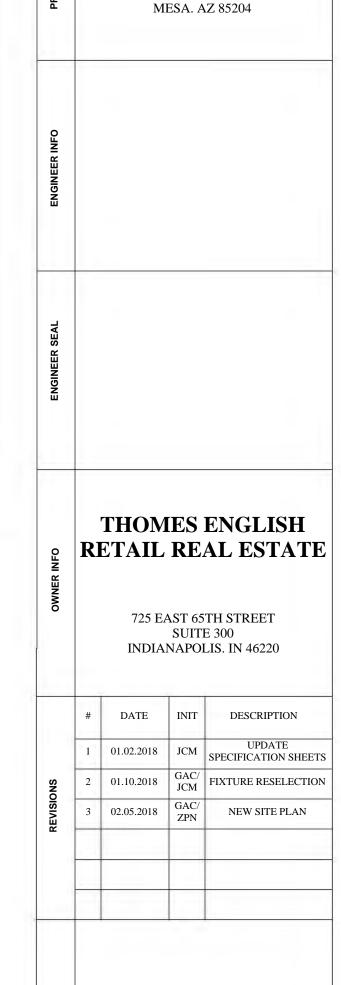

POLE MOUNT

FIXTURE

SPECIFICATION

SHEETS

TE171228-2

12.28.2017

N/A

Z. NORDIN

J. MACKEY

SL3.2

On-Site Lighting & Survey, LLC

1111 HIGHWAY 25 NORTH **SUITE 201 BUFFALO MN 55313**

> PH:763.684.1548 FAX:763.682.9048

1961 VAL VISTA

HABIT

1961 VAL VISTA DRIVE

POLE MOUNT FIXTURE TYPE JB-2R ROTATE RIGHT **SPECIFICATION SHEETS**

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PH: 763.684.1548